


SHEET INDEX

- LOCALITY PLAN AND SHEET INDEX
- CONSTRUCTION NOTES
- TYPICAL CROSS SECTIONS
- ENGINEERING DETAIL PLAN & SERVICE OFFSET TABLE
- 5-8. BLUE LILY CIRCUIT LONGITUDINAL & CROSS
- **SECTIONS 1-4**
- DRAINAGE LONGITUDINAL SECTIONS & PIT SCHEDULE
- SIGNAGE AND LINEMARKING PLAN 10.

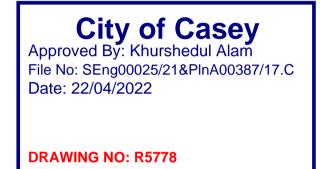

REV	DATE	[DESCRIPTION		STATUS
A	09/11/2021	FIRST COL	INCIL SUBMISSION		PRELIMINARY
В	08/12/2021		DMMENTS 11/11/202 ER MAIN AMENDMEN		PRELIMINARY
С	10/02/2022	VEHICLE CROSS	PRELIMINARY		
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DESIGNED:	M.LERNER	DATE:	18/10/2021	DATE PRINTED: 31/03/2022	
AUTHORISE	D: T.SMITH	DATE:	18/10/2021		
	L	CHAR A N D D E V E L IZA WAY, MT ELIZA VIC 3	ΟΡΜΕΝΤ		GG ANTS
CITY C	OF CASEY				
TITLE:	TION VILLAGE	AGE 5	GE		
JUNCT THE JU	AIG ROAD, JU				
JUNCT THE JU 45 CR/	AIG ROAD, JU	D SHEET INDE			

CONSTRUCTION NOTES


- ALL LEVELS AND DIMENSIONS ARE IN METRES UNLESS OTHERWISE SPECIFIED.
- 2. ALL WORKS ARE TO BE CARRIED OUT IN ACCORDANCE WITH THE CURRENT AUTHORITY STANDARDS, SPECIFICATIONS AT THE IN ACCORDANCE WITH THE AUSTRALIAN STANDARD GENERAL CONDITIONS OF CONTRACT AS 2124-1992.
- 3. STANDARD DRAWINGS OF THE RELEVANT ROAD AUTHORITY ARE AN ANNEXURE TO THE CONSTRUCTION DRAWINGS
- THE CERTIFIED PLAN OF SUBDIVISION IS AN ANNEXURE TO THE CONSTRUCTION DRAWINGS 4.
- MELBOURNE WATER PLANS FOR WETLANDS AND INFRASTRUCTURE (WHERE APPLICABLE) ARE AN ANNEXURE TO THE CONST 5.
- THE SCHEDULE OF QUANTITIES ARE AN ANNEXURE TO THE CONSTRUCTION DRAWINGS. IT IS THE RESPONSIBILITY OF THE CO 6 QUANTITIES REFLECT THAT OF THE CONSTRUCTION WORKS DETAILED IN THESE PLANS. THE SUPERINTENDENT IS TO BE NOT DISCREPANCIES BE IDENTIFIED.
- ALL DISTURBED AREAS ARE TO BE GRADED, TOPSOILED TO A MINIMUM DEPTH OF 150 MILLIMETRES AND SOWN WITH APPROV SATISFACTION OF THE SUPERINTENDENT.
- APPROVAL FOR THE USE OF WATER FOR CONSTRUCTION PURPOSES IS THE RESPONSIBILITY OF THE CONTRACTOR. REFER 8 AUTHORITY FOR SPECIFIC REQUIREMENTS AND APPROVALS.
- IT IS THE CONTRACTORS RESPONSIBILITY TO PROVE THE LOCATION AND DEPTH OF ALL EXISTING SERVICES PRIOR TO THE C 9 THE SUPERINTENDENT IS TO BE NOTIFIED SHOULD ANY DISCREPANCIES BE IDENTIFIED.
- SITE ACCESS MUST BE MAINTAINED AT ALL TIMES. TRAFFIC MANAGEMENT PLAN MUST BE PROVIDED TO THE RELEVANT ROAD 10. APPROVED) /SUPERINTENDENT PRIOR TO THE COMMENCEMENT OF WORKS.
- ACCESS TO THE EXISTING RESIDENCE TO BE MAINTAINED AT ALL TIMES. 11.
- THE CONTRACTOR IS RESPONSIBLE FOR ALL ENVIRONMENTAL CONTROLS TO THE SATISFACTION OF THE RELEVANT AUTHOR 12.
- 13. APPROPRIATE INSPECTIONS ARE TO BE ARRANGED WITH THE COUNCIL WORKS SUPERVISOR
- 14. ALL VEGETATION TO BE RETAINED AS SPECIFIED IS TO BE PROTECTED (TPZ FENCING) PRIOR TO THE COMMENCEMENT OF WO
- ALL FILLING WORKS ARE TO BE UNDERTAKEN IN ACCORDANCE WITH THE GEOTECHNICAL REPORT (REPORT No. 1200294-1) AN 15. LEVEL 1 SUPERVISION. A COMPACTION REPORT IS TO BE PROVIDED UPON COMPLETION OF THE FILLING WORKS.
- ALL BATTERS SHALL BE BLENDED INTO THE NATURAL SURFACE TO THE SATISFACTION OF THE SUPERINTENDENT. 16.
- MINIMUM FALL ON LOTS IS TO BE 1 IN 150 LONGITUDINALLY. 17.
- 18 PRIOR TO THE FILLING OF EXISTING OPEN DRAINS. CHANNELS OR DAMS A SUITABLY QUALIFIED GEOTECHNICAL CONSULTANT IS SUITABLE FOR FILLING AND THE INVERT LEVELS ARE TO BE TAKEN TO ENSURE THE AS-CONSTRUCTED FILL DEPTHS CAN B
- 19 THE CONTRACTOR IS RESPONSIBLE FOR ALL SERVICE TRENCHING AND BACKFILLING FOR DRAINAGE. SEWER. POTABLE AND ELECTRICAL, TELECOMMUNICATIONS AND GAS INCLUDING THE REMOVAL/DISPOSAL OF EXCESS MATERIAL.
- REFER TO THE RELEVANT SERVICE PLANS FOR WORKS ASSOCIATED WITH MELBOURNE WATER WORKS. SEWER. POTABLE AN 20. ELECTRICAL. TELECOMMUNICATION AND GAS SUPPLY. THESE SERVICES ARE REFLECTED ON THE DETAIL PLANS INDICATIVEL MINOR AMMENDMENTS.
- LOCATIONS FOR SERVICE CONDUITS SHALL BE DETERMINED FROM THE RELEVANT SERVICE PLANS. WHERE THESE ARE REQU 21. SUPERINTENDENT WILL CONFIRM THESE LOCATIONS AS REQUIRED. POTABLE & NON-POTABLE WATER AND GAS CONDUITS SH FROM TITLE BOUNDARIES (SIDE) WHERE POSSIBLE. CONDUIT LOCATIONS SHOULD BE POSITIONED IN CONJUNCTION WITH THI
- A.G DRAINS TO BE CONSTRUCTED BEHIND ALL KERB AND CHANNEL AND LONGITUDINAL PAVEMENT JOINTS 22.
- RCP DRAINAGE PIPES TO BE CLASS 2. RUBBER RING JOINTED UP TO Ø675mm UNLESS OTHERWISE SPECIFIED 23.
- ALL DRAINAGE LINES IN ROAD RESERVES. UNDER PAVEMENTS. VEHICLE CROSS-OVERS ARE TO BE BACKFILLED WITH FCR AS 24. AUTHORITY SPECIFICATIONS.
- 25. ALL EASEMENT DRAINS ARE AT 1 METRE OFFSET UNLESS OTHERWISE SPECIFIED.
- 26. ALL PIT FLOORS ARE TO BE SHAPED TO ACCOMMODATE DROP THROUGH PITS. ALL PITS TO BE CONSTURCTED TO THE COUNC
- 27. ALL PIT LIDS ARE TO BE IN ACCORDANCE WITH THE COUNCIL/EDCM SPECIFICATIONS
- ALL PROPERTY INLET DRAINS TO BE Ø225mm AND MUST BE A MINIMUM OF 500 MILLIMETRES BELOW THE FINISHED SURFACE 28. THE COUNCIL/EDCM SPECIFICATIONS.
- SUBGRADE IMPROVEMENT IS TO BE APPROVED BY THE SUPERINTENDENT AND COUNCILS WORKS SUPERVISOR PRIOR TO CC 29.
- 30. PAVEMENT DEPTHS ARE TO BE CONSTRUCTED IN ACCORDANCE WITH THE APPROVED PLANS AND GEOTEHCNICAL REPORT (CHANGES TO THESE DEPTHS MUST BE APPROVED BY COUNCILS WORKS SUPERVISOR AND THE SUPERINTENDENT.
- THE CONTRACTOR SHALL CONTACT THE SUPERINTENDENT FOR THE CO-ORDINATION OF ELECTRICAL WORKS AT LEAST 28 D/ 31. COMMENCEMENT.
- 32. ELECTRICAL AND TELECOMMUNICATIONS CABLES ARE TO BE PLACED IN A SHARED TRENCH TO THE SPECIFICATIONS OF THE
- 33. CONDUIT LOCATIONS AND PROPERTY DRAIN INLET LOCATIONS ARE TO BE STAMPED ON KERB AND CHANNEL AND FOOTPATH COUNCIL/EDCM SPECIFICATIONS.
- FOOTPATHS ARE TO CONSTRUCTED 1.5 METRES WIDE AND 2.5 METRES WIDE (SHARED) IN ACCORDANCE WITH COUNCIL/EDCM SPECIFICATIONS. 34.
- PEDESTRIAN CROSSINGS THROUGH SPLITTER ISLANDS ARE TO BE CONSTRUCTED AT PAVEMENT LEVEL. 35.
- 36. VEHICLE CROSOVERS ARE SHOWN INDICATIVELY. CONSTRUCTION REQUIREMENTS INCLUDING OFFSETS ARE TO BE IN ACCORDANCE WITH COUNCIL/EDCM **SPECIFICATIONS**
- 37. WHERE ALLOTMENTS ARE FILLED ABOVE FOOTPATH LEVELS. VEHICLE CROSSOVERS ARE TO BE CUT INTO ALLOTMENTS AT A MAXIMUM GRADE OF 1 IN 5
- 38. TBM AND PSM LOCATIONS ARE SHOWN ON SHEET 4
- 39. STREET SIGNS ARE TO BE INSTALLED IN ACCORDANCE WITH COUNCIL/EDCM SPECIFICATIONS.
- SIGNAGE. LINE MARKING AND PAVEMENT MARKERS ARE TO BE INSTALLED IN ACCORDANCE WITH AS1742.2 2009. AND COUNCIL/EDCM SPECIFICATIONS 40
- TACTILE INDICATORS ARE TO BE INSTALLED IN ACCORDANCE WITH AS1428.4.1 2009 AND VICROADS ROAD DESIGN NOTE 06-06. GUIDELINES FOR THE 41. PLACEMENT OF TGSI AT ALL PRAM CROSSINGS. FOOTPATH JUNCTIONS IN ACCORDANCE WITH COUNCIL/EDCM REQUIREMENTS
- THE PLANS MAY ONLY BE REPRODUCED IN THEIR ENTIRETY. 42
- 43 KERB RADII LABELS ARE IN METRES AND INDICATE BACK OF KERB DIMENSIONS.


	CITY	OF CASEY NOTES:			
	1.	ALL WORKS TO BE ACCORDANCE WITH CURRENT CITY OF CASEY AND/OR EDCM SPECIFICATIONS /	AND STAN	IDARD DRAW	INGS AND TO THE SATISFACTION
		OF THE CITY OF CASEY SUPERVISING ENGINEER.			
THE TIME OF CONSTRUCTION AND	2.	PRIOR TO COMMENCING WORKS ON SITE THE CONTRACTOR MUST ADDRESS ALL OCCUPATIONAL	HEALTH 8	SAFETY AC	T (2004) ITEMS AND ENSURE
		THAT THE REQUIRED NOTIFICATIONS HAVE BEEN MADE TO THE VICTORIAN WORKCOVER AUTHOR	ITY, HEAL	TH & SAFETY	DIVISION REGARDING TRENCHING
		OPERATIONS.			
	3.	PRIOR TO COMMENCING ANY WORKS ON TRENCHES WITH DEPTHS EXCEEDING 1.5M THE CONTRA	CTOR'S C	ONSTRUCTIO	ON SUPERVISOR MUST GIVE
STRUCTION DRAWINGS.		WRITTEN NOTICE TO WORKSAFE VICTORIA IN ACCORDANCE WITH PART 5.1, DIVISION 4 OF THE OC	CCUPATIC	NAL HEALTH	& SAFETY REGULATIONS
CONTRACTOR TO CONFIRM THE		(2017) & UNDERTAKE THE NECESSARY SAFETY PRECAUTIONS FOR TRENCHING OPERATIONS IN AC	CORDAN	CE WITH THE	WORKCOVER CODE OF PRACTICE
OTIFIED SHOULD ANY		(2018).			
OVED SEED MIX TO THE	4.	PAVEMENT DEPTHS MAY NEED TO BE MODIFIED DURING CONSTRUCTION, DEPENDING ONTHE ON-	SITE CON	DITIONS AS E	DIRECTED BY THE CASEY
		CONSTRUCTION ENGINEER OR WORKS SUPERVISOR.			
R TO THE RELEVANT WATER	5.	STREET LIGHTING MUST BE PROVIDED ON ALL NEWLY CREATED ROADS AND RESERVES IN ACCOR	RDANCE W	/ITH THE APP	ROVED PUBLIC LIGHTING PLAN
NTO THE RELEVANT WATER	6.	TREE RESERVE FENCES TO BE SHOWN ON CONSTRUCTION PLANS			
E COMMENCEMENT OF WORKS.	7.	APPROPRIATE SILTATION CONTROL IS TO BE CARRIED OUT DURING THE CONSTRUCTION AND MAII	NTENANC	E PERIODS	
COMMENCEMENT OF WORKS.	8.	AN ENVIRONMENTAL MANAGEMENT PLAN (EMP) MUST BE SUBMITTED TO, AND APPROVED BY COU	NCIL PRIC	OR TO THE CO	OMMENCEMENT OF ANY WORKS ON
AD AUTHORITY (AND		SITE AND ALL WORKS MUST BE CARRIED OUT IN ACCORDANCE WITH THIS EMP			
	9.	CUT BATTERS ARE TO BE HYDRO MULCHED USING APPROVED SEED MIXES.			
	10.	REMOVAL OR RETENTION OF EXISTING TREES OR VEGETATION MUST BE IN ACCORDANCE WITH TH	HE APPRC	OVED LANDSC	CAPE PLAN (OTHERWISE
ORITIES AND EPA REQUIREMENTS.		APPROVAL WILL BE REQUIRED FROM CASEY ARBORIST OR LANDSCAPE OFFICER.)			
	11.	NO SURPLUS TREES, VEGETATION OR OTHER MATERIALS IS TO BE BURNT ON SITE.			
WORKS	12.	ALL FOOTPATHS AND SHARED PEDESTRIAN-BICYCLE PATHS ARE TO BE 125MM THICK REINFORCED	D CONCRE	ETE USING SI	_72 MESH AS PER EDCM 401
AND UNDERTAKEN UNDER	13.	IF IMPORTED FILL MATERIAL IS TO BE PLACED ON SITE CLEAN FILL CERTIFICATES MUST BE PROVI	DED FRO	M A NATA AP	PROVED TESTING
		LABORATORY IN ACCORDANCE WITH EPA BULLETIN PUBLICATION NO. 448 TO DEMONSTRATE ITS S	SUITABILIT	Y FOR USE C	ON SITE.
	14.	FILLING IN ALL PROPERTIES & ROAD RESERVES IS TO BE CARRIED OUT USING APPROVED CLAY FI	LL. TOPS	OIL & ALL VE	GETABLE MATTER TO
		BE STRIPPED FROM SITE PRIOR TO FILLING. ALL FILLING TO BE CARRIED OUT IN 150MM LAYERS AN	ND COMPA	ACTED TO 95°	% OF MAX. DRY DENSITY.
ANT SHOULD VERIFY THE BASE		ALL FILLING TO COMPLY WITH AS 3798-2007, SECTION 8.2, LEVEL 1 A FILL REPORT MUST BE SUBMIT	ITED FRO	M A NATA RE	GISTERED SOIL TESTING
BE VERIFIED.		LABORATORY			
ID NON-POTABLE WATER,	15.	DAMS TO BE LEVELED PRIOR TO FILLING AND LEVELS SHOWN ON "AS CONSTRUCTED"PLANS			
	16.	STRUCTURAL FILL PADS WILL BE REQUIRED FOR ANY COMMUNITY, FAMILY OR CHILDRENS CENTRE	ES IN CON	SULTATION V	WITH CASEY'S BUILDING
AND NON-POTABLE WATER,	. –	MANAGEMENT TEAM			
ELY AND MAY BE SUBJECT TO	17.	IF ANY EXISTING SUBSTANDARD FILLING IS ENCOUNTERED ON THE SITE IT MUST BE REMOVED AND			
		PROPERLY COMPACTED TO COUNCIL REQUIREMENTS. A GEO-TECHNICAL REPORT MUST BE SUBM	III IED SH	OWING DETA	ALS OF DEPTH, TYPE OF MATERIAL
EQUIRED TO BE ALTERED THE	40	AND DENSITY OF THE FILL AREAS CONCERNED		SION DETAILS	
SHOULD BE A MINIMUM OF 4 METRES	18.	ALL COUNCIL RESERVES MUST BE PROVIDED WITH CONNECTIONS FOR DRAINAGE,			'n
THE RELEVANT SUB-CONTRACTOR	10	SEWERAGE, ELECTRICITY & OTHER SERVICES	REV	DATE	DESCRIPTION
	19.	INDUSTRIAL STRENGTH VEHICLE CROSSINGS TO BE PROVIDED FOR LOTS IN ADJACENT TO			
	20.	TEMPORARY CRUSHED ROCK TURN AROUND AREAS ON 'DEAD END' ROADS TEMPORARY CRUSHED ROCK TURN AROUND AREAS MUST BE MAINTAINED IN A SAFE AND	A	09/11/2021	FIRST COUNCIL SUBMISSION
AS PER THE RELEVANT	20.	SOUND CONDITION SO THAT VEHICLES ARE ABLE TO USE THEM AT ALL TIMES	в	08/12/2021	COUNCIL COMMENTS 11/11/2021
	21.	CONCRETE IS TO BE PLACED AROUND ELECTRICAL DISTRIBUTION PITS TO A MINIMUM DEPTH		00/12/2021	& MINOR WATER MAIN AMENDMENTS
	۷۱.	OF 200MM. DISTRIBUTION PITS ARE TO BE A MINIMUM OF 300MM FROM EDGE OF FOOTPATHS	С	10/02/2022	VEHICLE CROSSOVER CHANGE LOT 520
INCIL/EDCM SPECIFICATIONS.	22.	TELECOMMUNICATION CONDUITS ARE TO BE FOR USE BY ANY TELECOMMUNICATIONS			
	۲۲.	COMPANY			
E LEVELS AS REQUIRED BY	23.	TACTILE INDICATORS ARE TO BE INSTALLED IN ACCORDANCE WITH AS1428.4.1 'DESIGN FOR			
	20.	ACCESS AND MOBILITY' AT ALL PRAM CROSSINGS, BUS STOPS/ HARD STANDS,			
COMMENCEMENT OF WORKS.		ROUNDABOUTS/SIGNALS AND INTERSECIONS AND IN ACCORDANCE WITH EDCM 403.			
T (REPORT No. 1200294-1).	24.	A CCTV REPORT MUST BE PROVIDED FOR ALL DRAINAGE LINES PRIOR TO ISSUE OF			
		PRACTICAL COMPLETION.			
DAYS PRIOR TO THE PROPOSED				<u> </u>	
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HE RELEVANT AUTHORITIES. TH IN ACCORDANCE WITH			DRAWN:	O.FARNILL	DATE: 18/10/2021 SCALE:
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City of Casey Approved By: Khurshedul Alam File No: SEng00025/21&PInA00387/17.C Date: 22/04/2022

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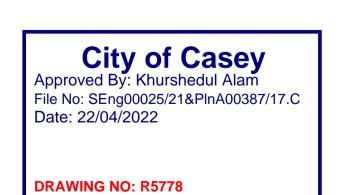
			KEGISTERED SOIL	TESTING		
"PLANS RENS CENTRES	IN CON	SULTATION	I WITH CASEY'S B	UILDING		
			PPROVED FILL MA FAILS OF DEPTH, 1		ERIAL	
	VERS	ION DETAIL	-S:			
NT TO	REV	DATE	D	DESCRIPTION		STATUS
AND	A	09/11/2021	FIRST COU	NCIL SUBMISSION		PRELIMINARY
	В	08/12/2021	COUNCIL CC & MINOR WATE	DMMENTS 11/11/2021 R MAIN AMENDMENTS	3	PRELIMINARY
1 DEPTH OTPATHS S	С	10/02/2022	VEHICLE CROSS	OVER CHANGE LOT 52	20	PRELIMINARY
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					I	



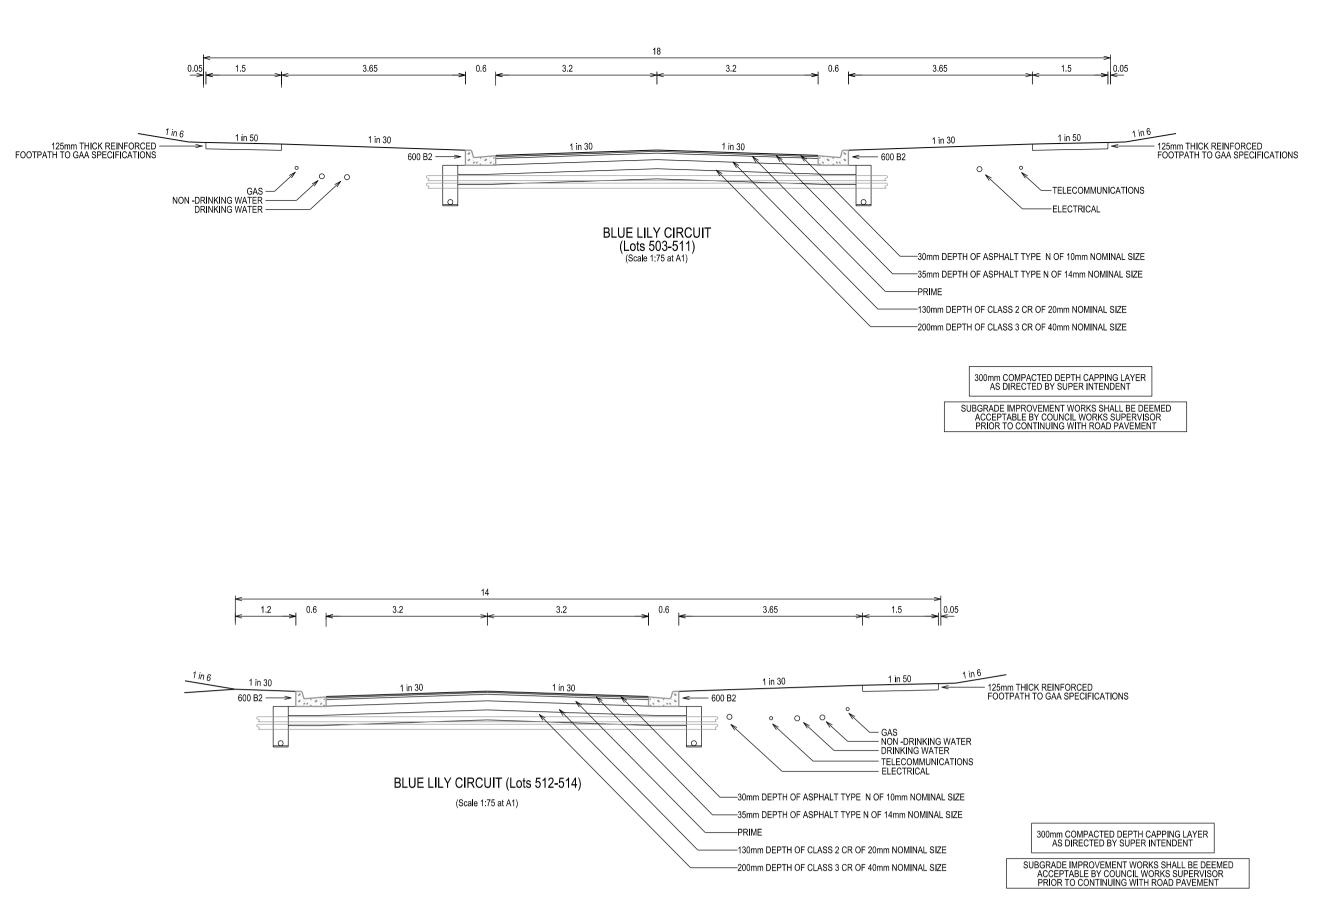

SUBGRADE IMPROVEMENT WORKS SHALL BE DEEMED ACCEPTABLE BY COUNCIL WORKS SUPERVISOR PRIOR TO CONTINUING WITH ROAD PAVEMENT	

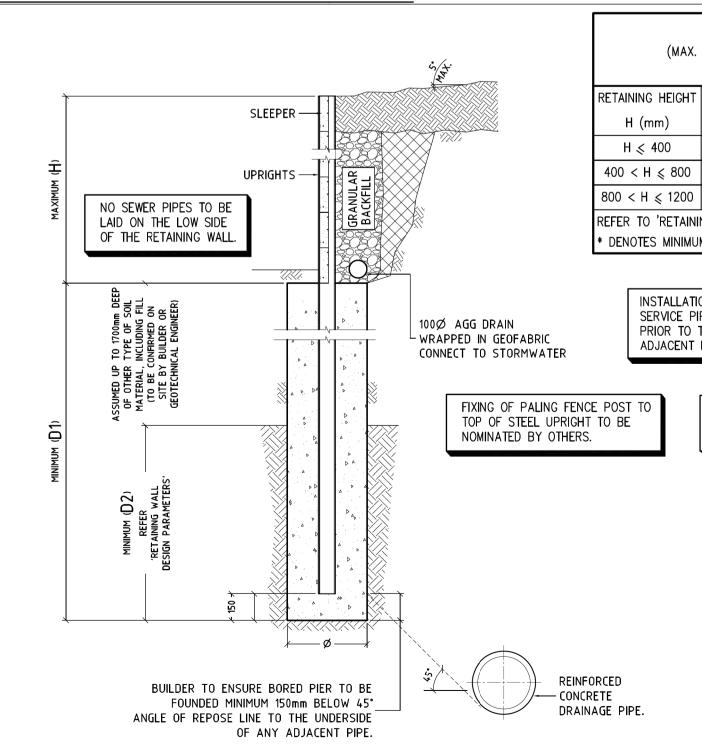_		ENCE WITH POSTS @ 2 INCLINATION OF BACK					
IT	SLEEPERS	UPRI	GHTS		FOOTINGS		END BEARING*
	SPECIFICATION	SPECIFICATION	SPACING (mm)	D1 (mm)	D2 (mm)	ø (mm)	(mm)
	MANUFACTURER DESIGN & SPECIFICATIONS	100UC 15 OR 150UB 14	2040	1900	1700	350	35
)	MANUFACTURER DESIGN & SPECIFICATIONS	100UC 15 OR 150UB 14	2040	2300	2200	350	35
0	MANUFACTURER DESIGN & SPECIFICATIONS	150UC 23 OR 180UB 16	2040	2500	2300	450	35
	NG WALL DESIGN PARAMETI I END BEARING OF SLEEPE		FLANGES.				
	REINFORCED CONCRETE TO BORED PIER SHALL MINIMUM 23KN ULTIMAT	BE DESIGNED BY M	ANUFACTURER.		PREPARE CIVILTEST REPORT	D BY Pty Ltd	GATION REPORT
Ļ							IN INFORMATION.




R15 — 300 SUBBASE COURSE CAPPING LAYER _______ -----+

600

LINE OF KERB ______


BARRIER KERB & CHANNEL DETAIL 600 B2 (Scale 1:12.5 at A1)

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А	09/11/2021	FIRST CO	OUNCIL SUBMISSION		PRELIMINAR		
В	08/12/2021	COUNCIL (& MINOR WA	COMMENTS 11/11/2021 ER MAIN AMENDMENT	S	PRELIMINAR		
С	10/02/2022	VEHICLE CROS	SOVER CHANGE LOT 5	20	PRELIMINAR		
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VERSION DETAILS:

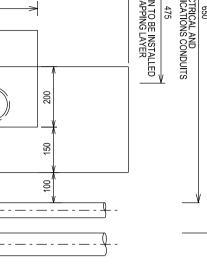__ APPROVED BACKFILL




Street	Gas	Gas		NDW		Water		nms	Ele	C.	Lighti	ng	Sewer	
Blue Lily Circuit (18m)	Ν	1.80	Ν	2.30	Ν	2.80	S	1.80	S	2.60	1.00	BOK	Ν	1.00
Blue Lily Circuit (14m)	W	1.80	W	2.30	W	2.80	W	3.30	W	4.10	1.00	BOK	-	-
SERVICE OFFSETS ARE MEASURED (m) FR	om the	E TITLE B	OUNDA	RYUNLE	ESS OT	HERWISE	SPEC	IFIED						

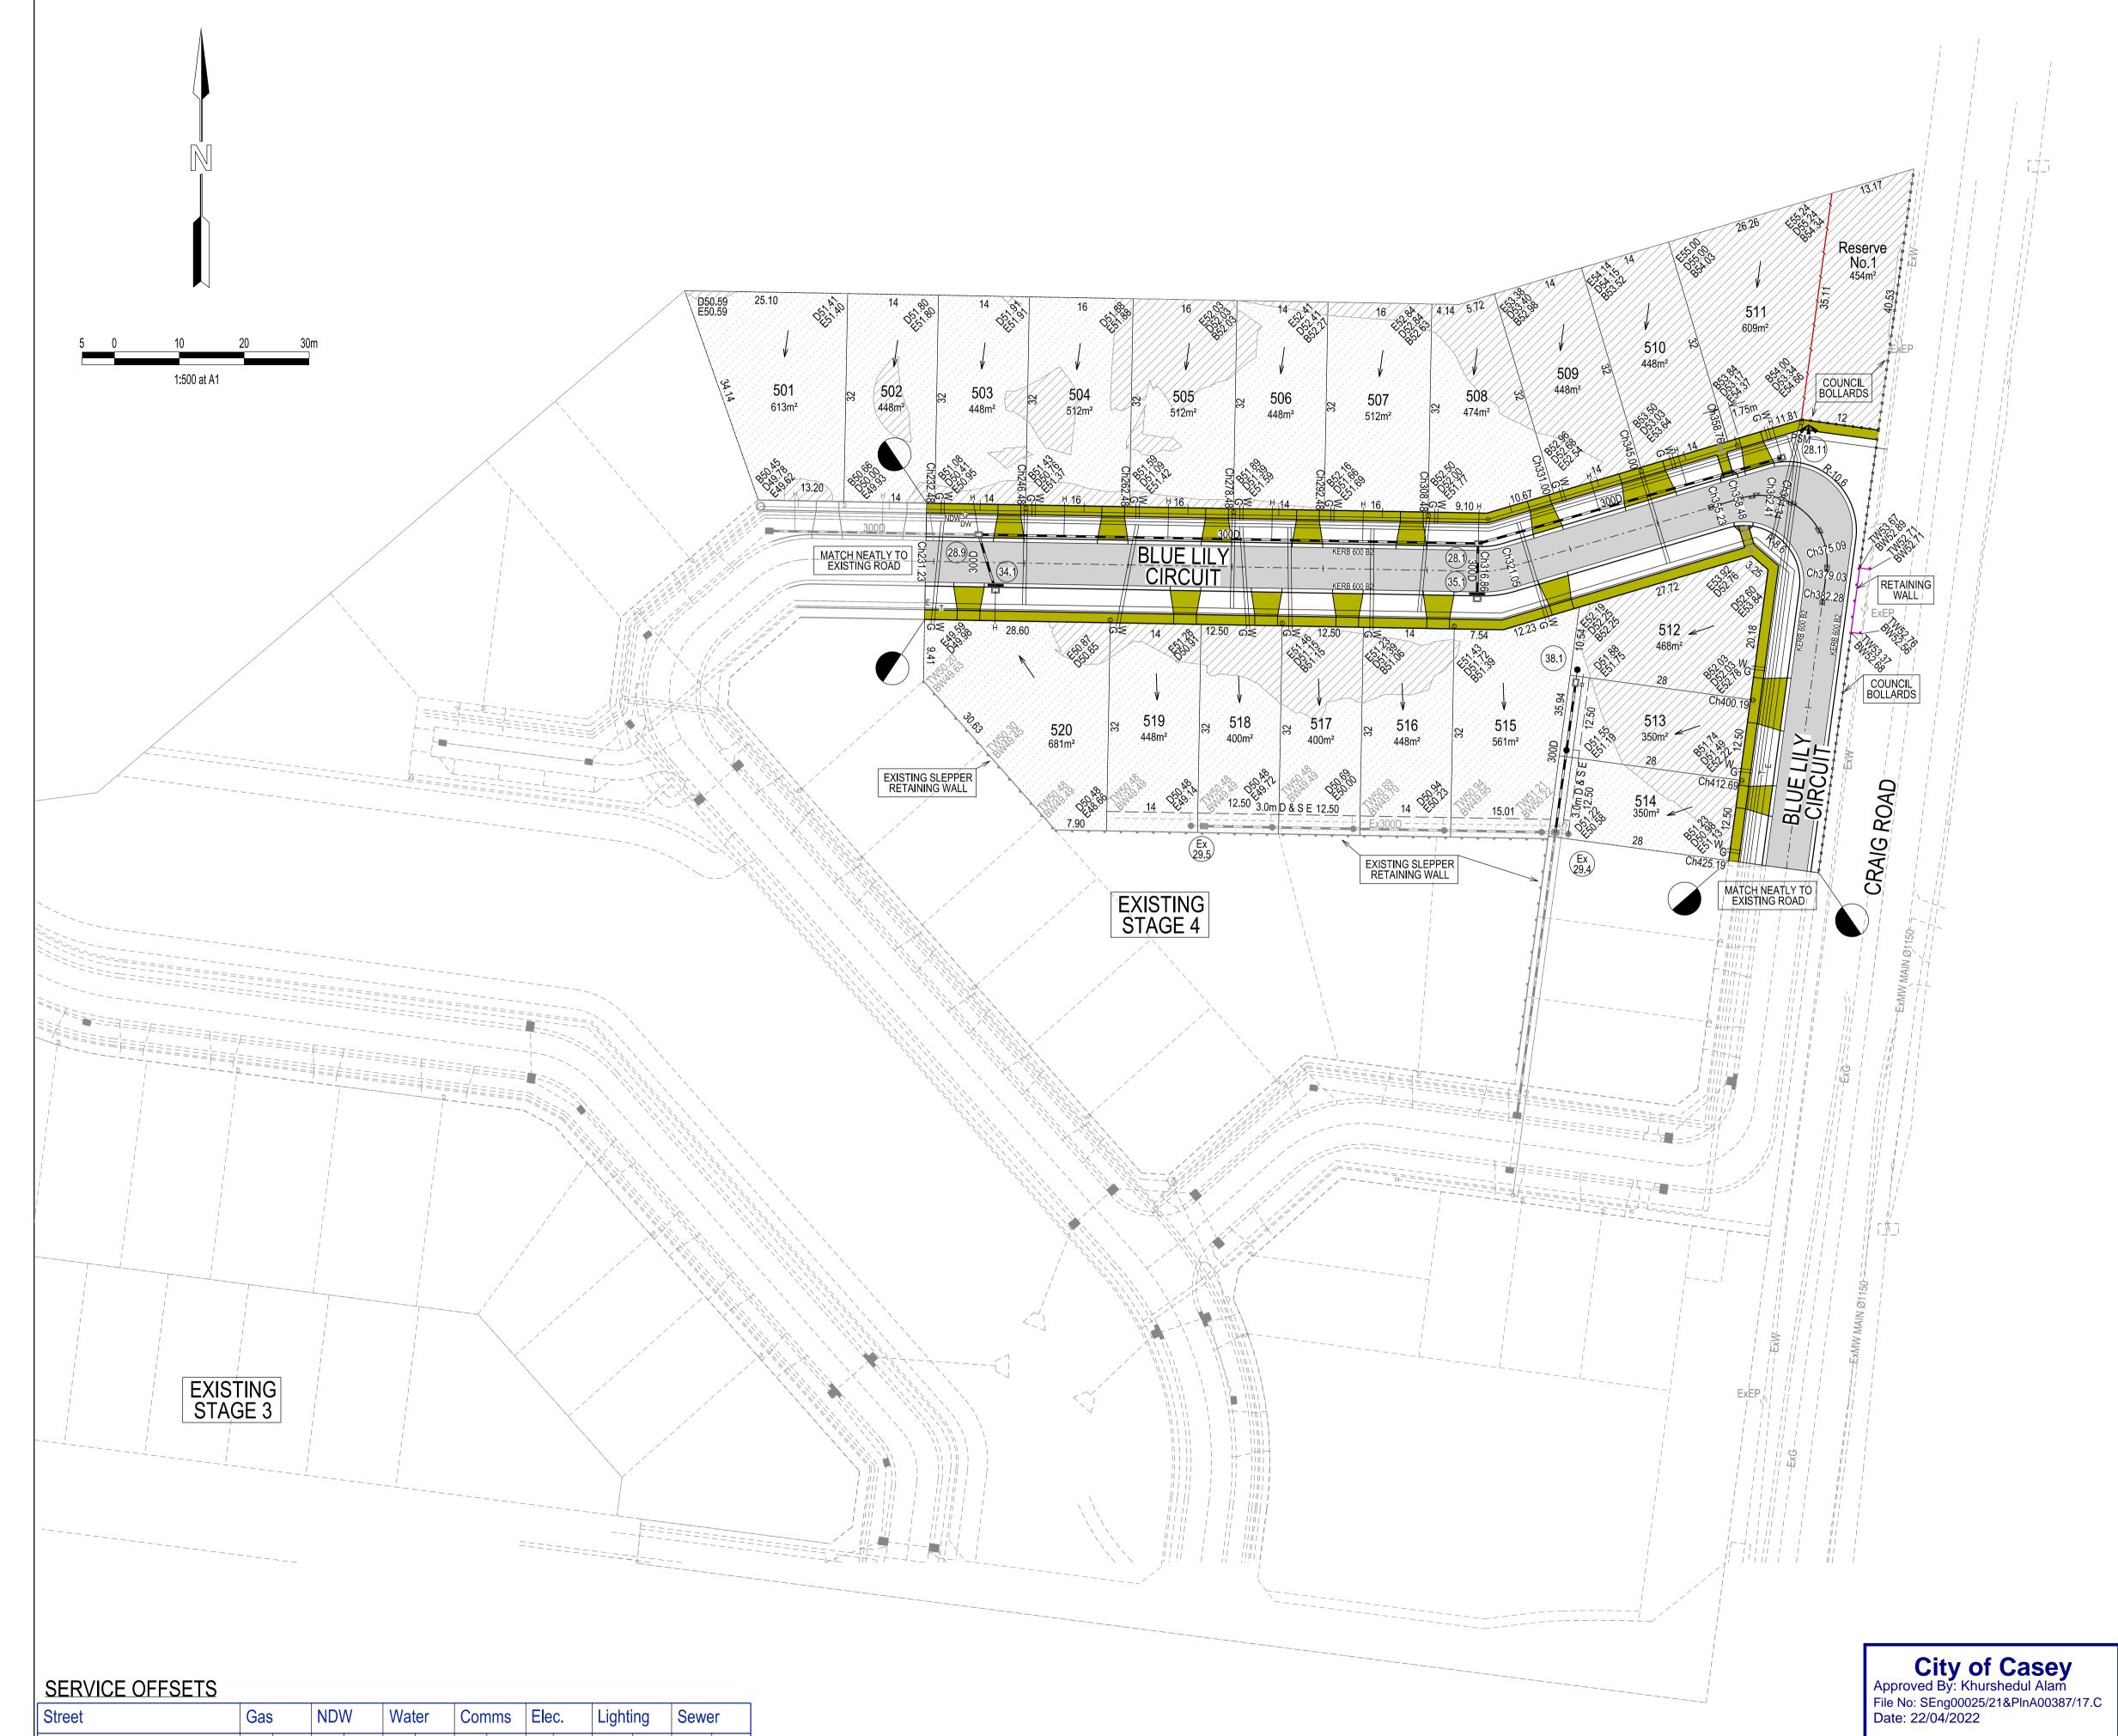
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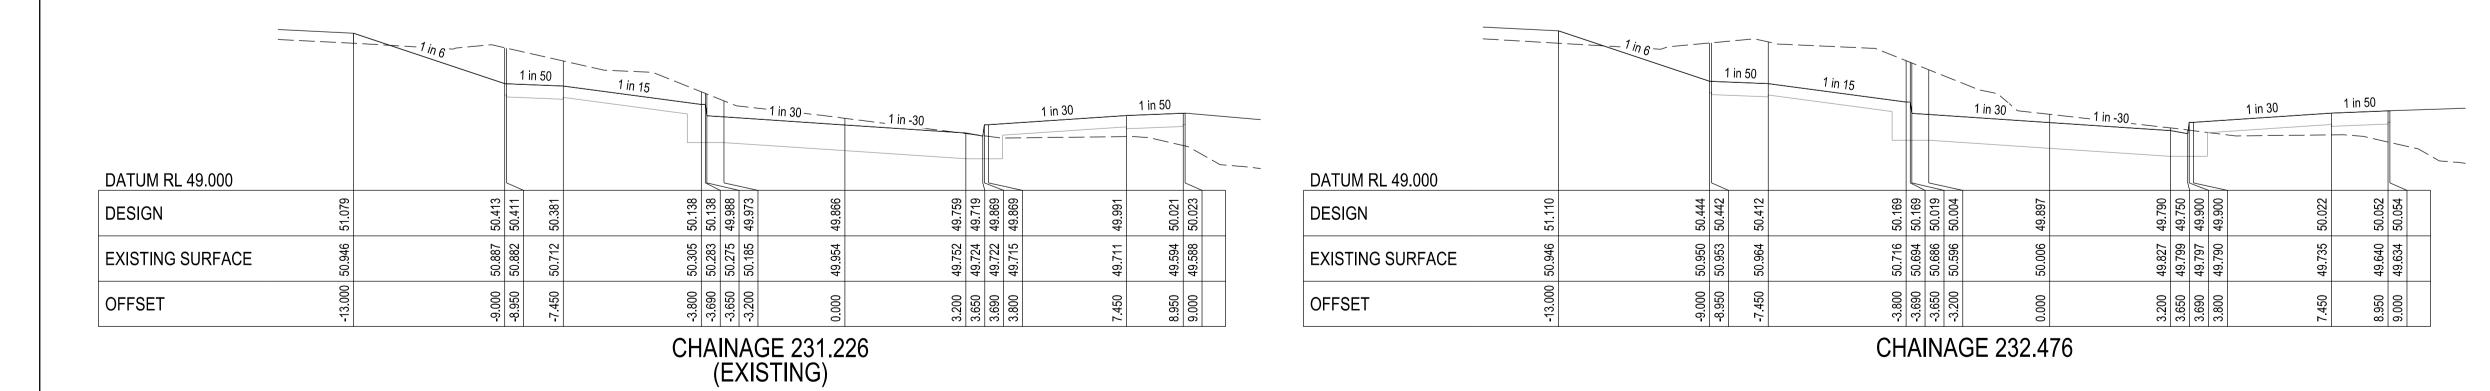
LEGEND

	FOOTPATH
	VEHICULAR CROSSOVER
	KERB AND CHANNEL
E-⊤	ELECTRICITY TELECOMMUNICATION } CONDUITS
G	GAS DRINKING WATER } CONDUITS NON DRINKING WATER
—— Е ——	ELECTRICITY MAIN
—— т ——	TELECOMMUNICATION MAIN
— G ———	GAS MAIN
— DW ———	DRINKING WATER MAIN
— NDW — o-, s₀	NON DRINKING WATER MAIN SEWER MAIN, MANHOLE, MAINTENANCE SHAFT AND SEWER PROPERTY BRANCHES
	PROPOSED DRAINAGE, PIT, HOUSE DRAIN AND PROPERTY INLET
Ex000D Fut D	EXISTING DRAINAGE AND PIT AND FUTURE DRAINAGE AND PIT
0.00	DRAINAGE PIT NUMBER
	PROPOSED CUT AREAS
	PROPOSED FILL AREAS
E00.00	EXISTING SURFACE LEVEL
D00.00	DESIGN SURFACE LEVEL
B00.00	TOP OF BATTER LEVEL
PD00.00	PRE-DEVELOPMENT LEVEL
° //	STREET NAME SIGN
	LOT SLOPE DIRECTION
	PERMANENT SURVEY MARK
۲	TEMPORARY BENCH MARK
	RETAINING WALLS (CONCRETE SLEEPER)
	RETAINING WALLS (MASS ROCK WALL)
	KERB TRANSITION
00	TRAFFIC SIGNAL PEDESTAL
	COUNCIL BOLLARDS
/	FENCE

VERS	SION DETAIL	_S:			
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В	08/12/2021	COUNCIL C & MINOR WAT	OMMENTS 11/11/2021 ER MAIN AMENDMENTS	3	PRELIMINARY
с	10/02/2022	VEHICLE CROS	SOVER CHANGE LOT 52	20	PRELIMINARY
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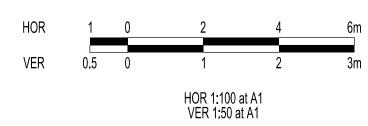


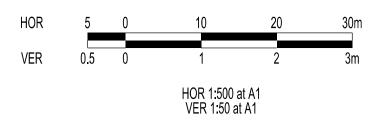

BLUE LILY CIRCUIT - LONGITUDINAL SECTION

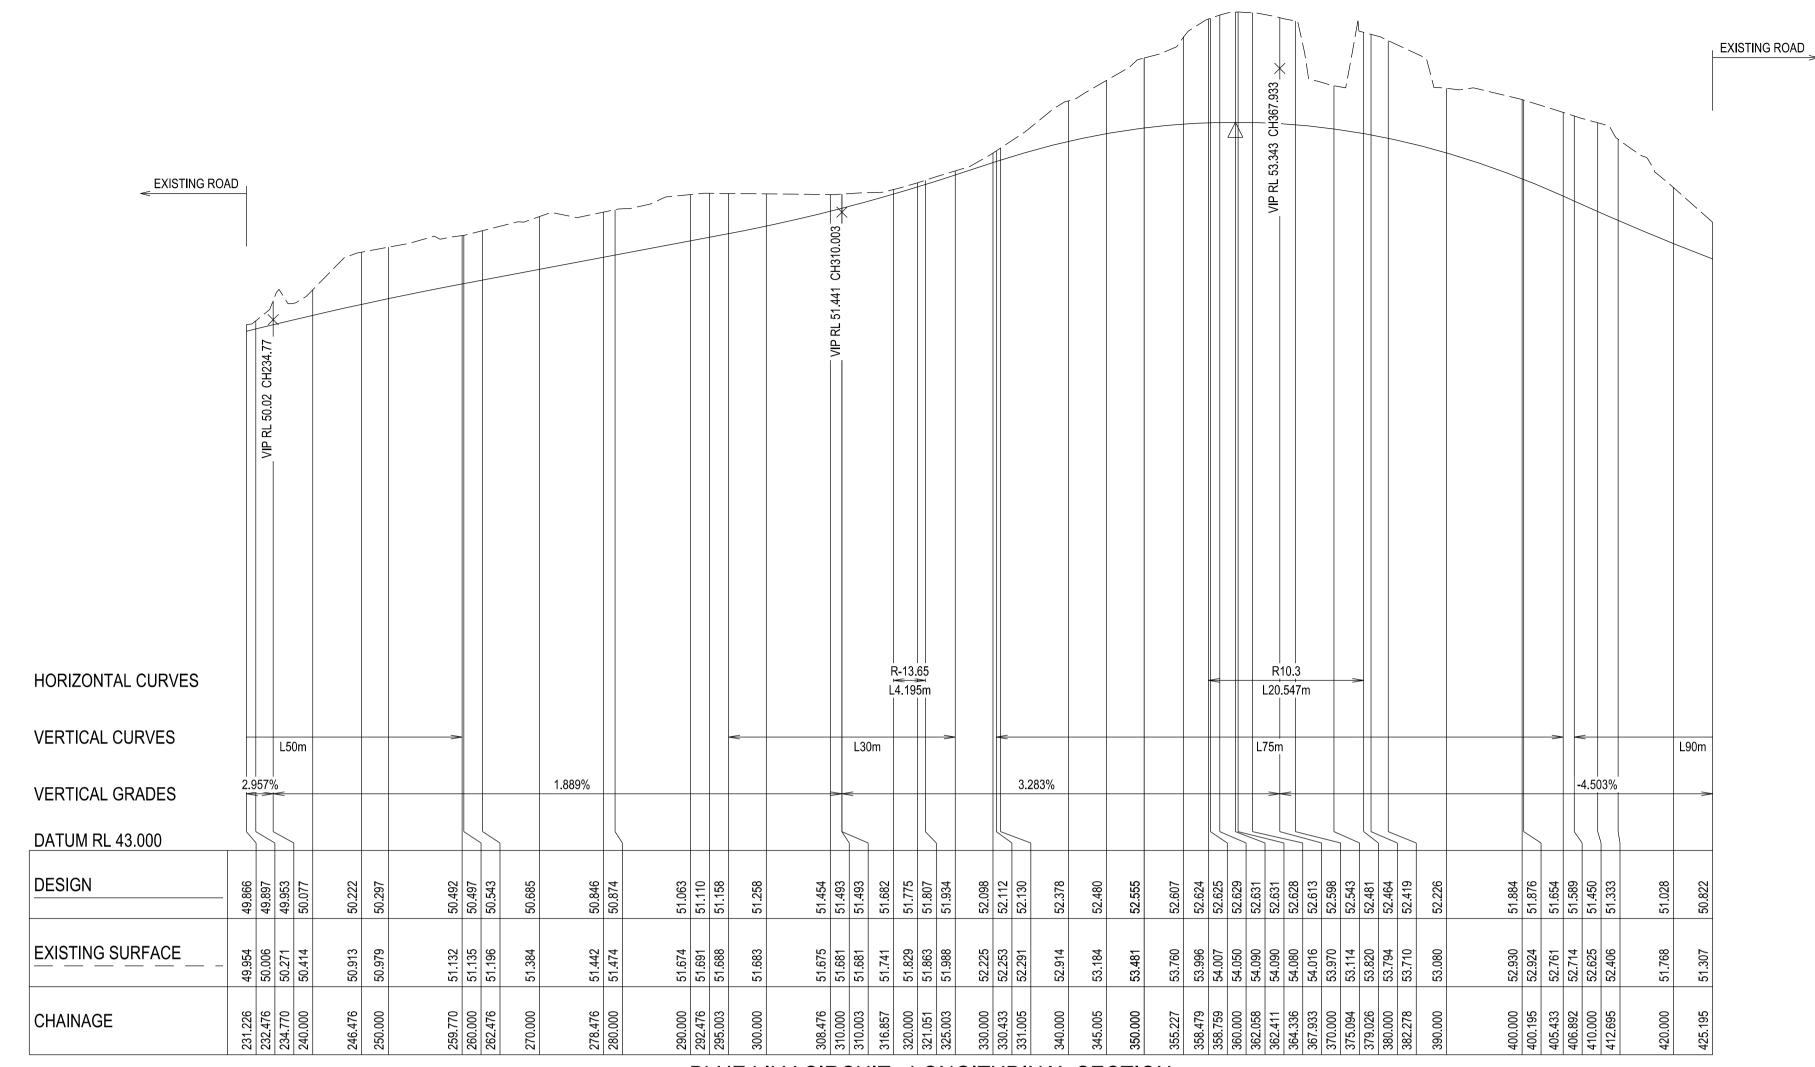A1 HORZ SCALE 1:500 A1 VERT SCALE 1:50

City of Casey Approved By: Khurshedul Alam File No: SEng00025/21&PInA00387/17.C Date: 22/04/2022



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SUITE 1, L SUITE 1, L www.charl COUNCIL: CITY OF (TITLE: JUNCTIO THE JUNC 45 CRAIG	EVEL 1, 84 MT ELIZA WAY tondegg.com.au CASEY N VILLAGE PTY CTION- STAGE \$	LTD ON VILLA	LTO ормент 930	CONSULTANT

DESCRIPTION

FIRST COUNCIL SUBMISSION

COUNCIL COMMENTS 11/11/2021 & MINOR WATER MAIN AMENDMENTS

VEHICLE CROSSOVER CHANGE LOT 520

STATUS

PRELIMINARY

PRELIMINARY

PRELIMINARY

VERSION DETAILS:

DATE

09/11/2021

08/12/2021

10/02/2022


REV

А

В

С


_			in 50	1 in 15				
					1 in 30	1 in -3	30 - 1 in 30 -	1 in 50
DATUM RL 50.000								
DATUM RL 50.000 DESIGN	52.157	51.657 51.655	51.625	51.382	51.382 51.232 51.217	51.110	51.003 50.963 51.113 51.113	51.235 51.265 51.267 51.267 51.103
EXISTING SURFACE	51.691 5:	51.687 5 51.687 5	51.707 5			51.691 5	51.504 5 51.464 5 51.460 5 51.450 5 51.450 5	51.343 5 51.343 5 51.357 5 51.358 5 51.367 5
OFFSET	-12.000 5	-9.000 5 -8.950 5	-7.450 5			0.000	3.200 5 3.650 5 3.850 5 3.850 5 3.850 5 3.800 5 5 3.800 5 5 3.800 5 5 3.800 5 5 5 5 5 5 5 5 5 5 5 5 5 5 5 5 5 5	7.450 5 8.950 5 9.000 5 9.984 5
	7	<u> </u>		<u> </u>	CHAINAGE		<u>ମ୍</u> ର୍ଥ୍ୟ ଅନ୍ୟ ଅନ୍ୟ ଅନ୍ୟ ଅନ୍ୟ ଅନ୍ୟ ଅନ୍ୟ ଅନ୍ୟ ଅନ	<u> </u>
		1 in 6	1 ir	n 50 1 in 15				
					1 ir	1 30	1 in -30	1 in 30 1 in 50
DATUM RL 50.000								
DESIGN	51.892		51.392 51.391	51.361	51.117 51.117 50.967 50.952	50.846	50.739 50.699 50.849 50.849	50.971 51.001 51.002
EXISTING SURFACE	51.640		51.591 51.590	51.565	51.505 51.503 51.502 51.495	51.442	51.389 51.391 51.393 51.395	51.357 51.355 51.355
		L	2 2	2		1		
	-12.000 51.6		-9.000 5 -8.950 5	-7.450 5	-3.800 -3.690 -3.650 -3.200	00000	3.650 3.650 3.800	7.450 8.950 9.000
							3.650 3.650 3.800	
OFFSET DATUM RL 49.500 DESIGN EXISTING SURFACE	51.504 51.590	<u>1 in 6</u>	51.423 51.090 -9.000 51.421 51.088 -8.950	1 in 15	51.276 50.815 51.273 50.815 51.273 50.815 51.272 50.665 51.272 50.665 51.259 50.665 51.259 50.665 51.259 50.650	E 278.476	51.158 50.437 00° - 10°	1 in 30 7.450 50.908 50.668 7.450 9.000 9.000 9.000
OFFSET DATUM RL 49.500 DESIGN	51.590	<u>1 in 6</u>	51.088	097 1 50 1 in 15 80 12 1 in 15	50.815 50.815 50.650 50.665 50.665 50.665 50.665 50.665 50.650 50.650	E 278.476	3200 51.158 50.437 00 3.650 51.142 50.397 00 3.650 51.141 50.547 3.650 3.650 3.650 3.650 3.690 3.800 51.137 50.547 3.800 51.137 50.547 3.800 51.137 50.547 50.577 50.577 50.577 50.577 50.577 50.577 50.577 50.577 50.577 50.577 50.577 50.577 50.577 50.577 50.577	1 in 30 20:000 1 in 30 1 in 50 89905 80000 1 in 50 1 in 50
OFFSET DATUM RL 49.500 DESIGN EXISTING SURFACE	51.504 51.590	<u>1 in 6</u>	51.423 51.090 -9.000 51.421 51.088 -8.950	1 in 15	-3.800 51.276 50.815 -3.690 51.273 50.815 -3.650 51.272 50.665 -3.650 51.272 50.665 -3.650 51.272 50.665 -3.200 51.259 50.650 -3.200 51.259 50.650	E 278.476	3200 51.158 50.437 00 3.650 51.142 50.397 00 3.650 51.141 50.547 3.650 3.650 3.650 3.650 3.690 3.800 51.137 50.547 3.800 51.137 50.547 3.800 51.137 50.547 50.577 50.577 50.577 50.577 50.577 50.577 50.577 50.577 50.577 50.577 50.577 50.577 50.577 50.577 50.577	1 in 30 7.450 50.908 50.668 7.450 9.000 9.000 9.000
OFFSET DATUM RL 49.500 DESIGN EXISTING SURFACE	51.504 51.590	<u>1 in 6</u>	-9.000 51.423 51.090 -9.000 -8.950 51.421 51.088 -	1 50 1 in 15 1 50 21 310 1 in 15 2 1 2008 2 1 2008 2 1 2008 2 1 2 1 2 1 2 1 2 1 2 1 2 1 2 1 2 1 2 1	-3.800 51.276 50.815 -3.690 51.273 50.815 -3.650 51.272 50.665 -3.650 51.272 50.665 -3.650 51.272 50.665 -3.200 51.259 50.650 -3.200 51.259 50.650	E 278.476	3200 51.158 50.437 00 3.650 51.142 50.397 00 3.650 51.141 50.547 3.650 3.650 3.650 3.650 3.690 3.800 51.137 50.547 3.800 51.137 50.547 3.800 51.137 50.547 50.577 50.577 50.577 50.577 50.577 50.577 50.577 50.577 50.577 50.577 50.577 50.577 50.577 50.577 50.577	1 in 30 7.450 50.908 50.668 7.450 9.000 9.000 9.000
OFFSET DATUM RL 49.500 DESIGN EXISTING SURFACE	51.504 51.590		-9.000 51.423 51.090 -9.000 -8.950 51.421 51.088 -	1 in 15	CHAINAG -3.800 51.276 50.815 -3.800 51.272 50.815 -3.800 51.272 50.815 -3.800 51.272 50.805 -3.800 51.285 -3.800 51.	E 278.476	9 3.650 3.650 3.650 51.137 50.547 3.650 51.137 50.547 3.650 3.750 3.650 3.7500 3	1 in 30 7.450 50.908 50.668 7.450 9.000 9.000 9.000
OFFSET DATUM RL 49.500 DESIGN EXISTING SURFACE OFFSET =	-12.000 51.504 51.590	$-1in_{6}$	-9.000 51.423 51.090 -9.000 -9.000 -9.000 -9.000 -9.000 -8.950 -9.000 -8.950 -8	997- 1 50 1 in 15 9850 12 9850 12 10 10 10 10 10	000 21376 50.815 -3.800 51376 50.815 -3.800 513273 50.815 -3.800 513273 50.815 -3.800 513273 50.815 -3.800 51329 50.650 -3.800 51329 50.550 -3.800 5129 50.550 -3.800 500 5129 50.550 -3.800 500 500 500 500 500 500 500 500 500	SE 278.476	0 1 in -30 3.650 1 in -30 0 3.690 51.137 50.347 1 in -30 0 0 1 in -30 0 0 1 in -30 0 0 0 0 0 0 0 0 0 0 0 0 0	1 in 30 1 in 30 1 in 30 1 in 30 1 in 50 1 in 50
OFFSET DATUM RL 49.500 DESIGN EXISTING SURFACE OFFSET = DATUM RL 49.500 ESIGN	51.436		50.769 -9.000 51.423 51.090 -9.000 50.767 -1 -8.950 51.421 51.088	097-2- 1 50 1 in 15 1 in 15 1 in 15 1 in 15 1 in 15 1 in 15 1 in 15	50.494 -3.800 51.276 50.815 50.494 -3.800 51.275 50.815 50.494 -3.690 51.272 50.815 50.344 -3.650 51.272 50.665 50.344 -3.650 51.272 50.665 50.329 -3.200 51.272 50.665 50.329 -3.200 51.272 50.665 50.329 -3.200 51.272 50.665	SE 278.476	0 50.116 50.076 50.076 50.076 50.076 50.076 50.076 50.437 3.650 51.158 50.437 3.650 51.142 50.397 3.650 51.141 50.547 3.650 51.137 50.547 3.800 51.137 50.547 3.800 51.137 50.547 5	1 in 30 1 in 50 20.317 20.317 20.317 20.317 20.317 20.314 20.315 20.314 20.315 20.314 20.315
OFFSET DATUM RL 49.500 DESIGN EXISTING SURFACE OFFSET	-12.000 51.504 51.590	$-\frac{1}{in_6}$	-9.000 51.423 51.090 -9.000 -9.000 -9.000 -9.000 -9.000 -8.950 -9.000 -8.950 -8	997- 1 50 1 in 15 9850 12 9850 12 10 10 10 10 10	000 1276 50.815 -3.800 51.276 50.815 -3.650 51.273 50.815 -3.650 51.273 50.815 -3.650 51.250 50.650 -3.200 50.650 -3.200 50.650 -3.200 50.750 -3.200 50.500 -3.200 50.750 -3.200 500 -3	SE 278.476	0 1 in -30 3.650 1 in -30 0 3.690 51.137 50.347 1 in -30 0 0 1 in -30 0 0 1 in -30 0 0 0 0 0 0 0 0 0 0 0 0 0	1 in 30 1 in 30 1 in 30 1 in 30 1 in 50 1 in 50

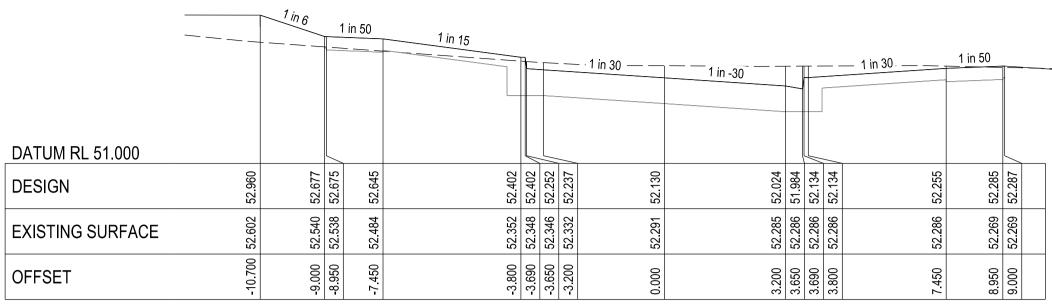




	1 in 5	50	1 in 15	_		1 in 30	1 in -30			1 in 30 1 in	50	1	in -6
DATUM RL 51.000													
DESIGN	52.354 52.352	52.322	52.079 52.079	51 000	51.914	51.807	51.701	51.661	51.811	51.811	51.962	51.964	51.793
EXISTING SURFACE	52.081 52.079	52.020	51.957 51.057	51.304 51.053	51.943	51.863	51.777	51.764	51.763	51.656	51.619	51.619	51.592
OFFSET	-9.000 -8.950	-7.450	-3.800 -3.600	3 650	-3.200	0000	3.200	3.650	3.690	3.800	8.950	000.6	10.029
			·				GE 321 051			· · ·			

CHAINAGE 321.051

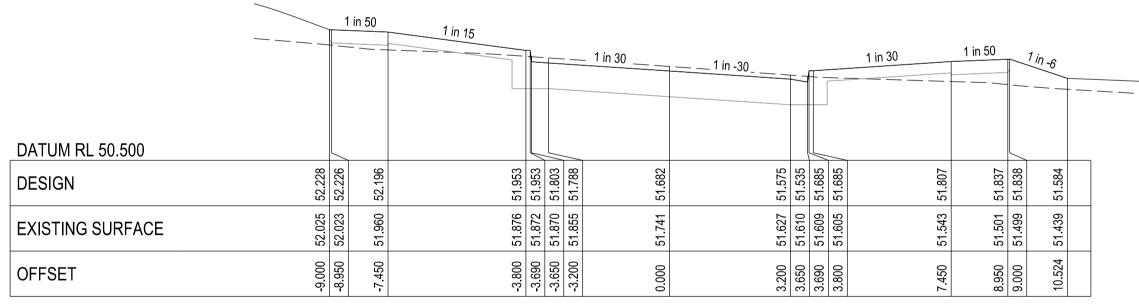

CHAINAGE 316.857

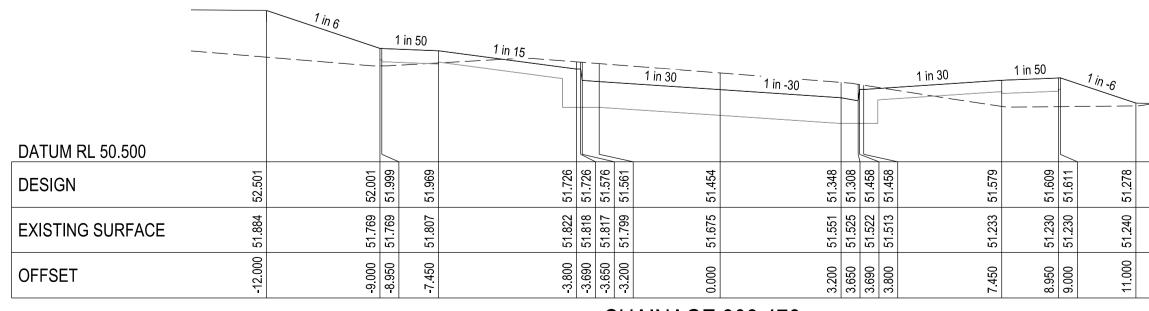



CHAINAGE 308.476

		HOR	1 0	2	4 6m	
		VER	0.5 0	1 HOR 1:100 at A1 VER 1:50 at A1	2 3m	
VERS	ION DETAIL	S:				
REV	DATE		D	ESCRIPTION		STATUS
A	09/11/2021		FIRST COU	NCIL SUBMISSION		PRELIMINAR
В	08/12/2021		COUNCIL CC & MINOR WATE	MMENTS 11/11/202' R MAIN AMENDMEN	1 ITS	PRELIMINAR
С	10/02/2022		VEHICLE CROSS	OVER CHANGE LOT	- 520	PRELIMINAR
FILENAME:	P:\1432\14	132_5\E\2	? - Design\6 - DGI	N\R06.dgn		
DRAWN:	O.FARNII	LL	DATE:	18/10/2021	SCALE: AS SHOWN	
DESIGNED:	M.LERNE	R	DATE:	18/10/2021	DATE PRINTED: 31/03/2022	
AUTHORISE	ED: T.SMITH	1	DATE:	18/10/2021		
www.	E 1, LEVEL 1, 84 M ⁻ .charltondegg.com.a		HAR D D E V E L AY, MT ELIZA VIC 39	LTO ормент 330		GG ANTS
JUNCT THE JI 45 CR/		STAGE JUNCT	5 Ton Villag			
DRG NO.		IF CR(USS SECTIO	DNS - SHEET REV.		
	5/R06			С	SHEET	06 OF 10

City of Casey Approved By: Khurshedul Alam File No: SEng00025/21&PInA00387/17.C Date: 22/04/2022

DRAWING NO: R5778

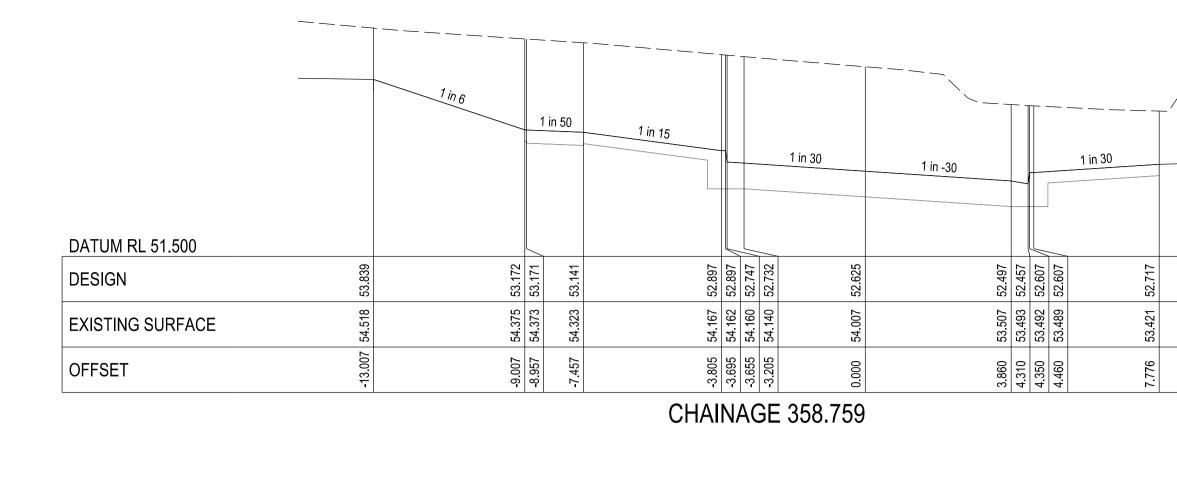

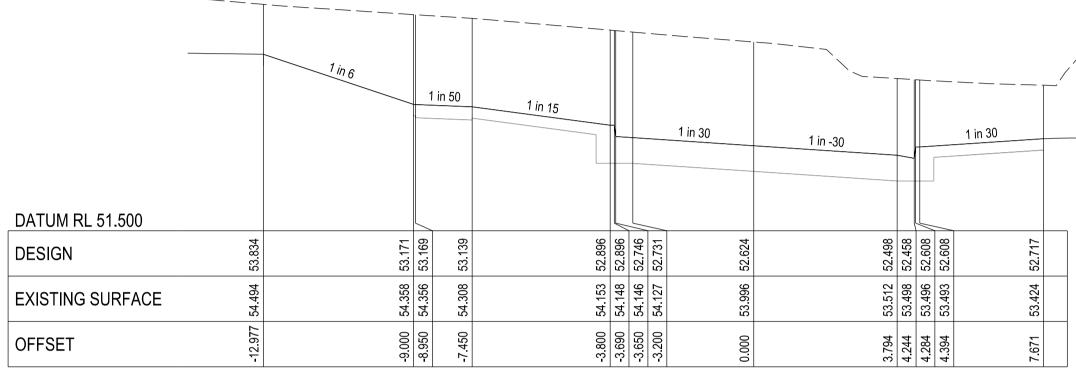



CHAINAGE 358.479

		1 in 6	1 ir	n 50	1 in 15				└ ─ ─ ─ ─					
DATUM RL 51.500								1 in 30	1 in -30				1 in 30	1 in 50
DESIGN	53.771	53.153	53.152	53.122	52.878	52.878	52.728 52.713	52.607	52.500	52.460	52.610	52.610	52.732	
EXISTING SURFACE	54.354	54.218	54.216	54.160	53. <u>986</u>	53.981	53.979 53.058	53.760	53,588	53.576	53.574	53.571	53.501	
OFFSET	-12.707	000.6-	-8.950	-7.450	-3.800	-3.690	3 650	000.0	3.200	3.650	3.690	3.800	7.450	


CHAINAGE 355.227


		1 in 6	1 in 50	1 in 15				1 in 30	 1 in -30				1 in 30	1 in 50
DATUM RL 51.500 DESIGN	53.503	53.027	53.025	C66.7C	52.752 52.752 52.753	52.602	52.587	52.480	C 0 0 1 0	52 333	52.483	52.483	52.605	50 635
EXISTING SURFACE	53.719	53.636	53.635	090.00		53.381		53.184	000 000 20	53.084	53.083	53.081	53.015	57 Q66
OFFSET	-11.860	000 [.] 6-	-8.950		-3.800	3.650	-3.200	0.000		3.650	3.690	3.800	7.450	8 05 <u>0</u>
					CI	HA	INA	GE 345.0	05					

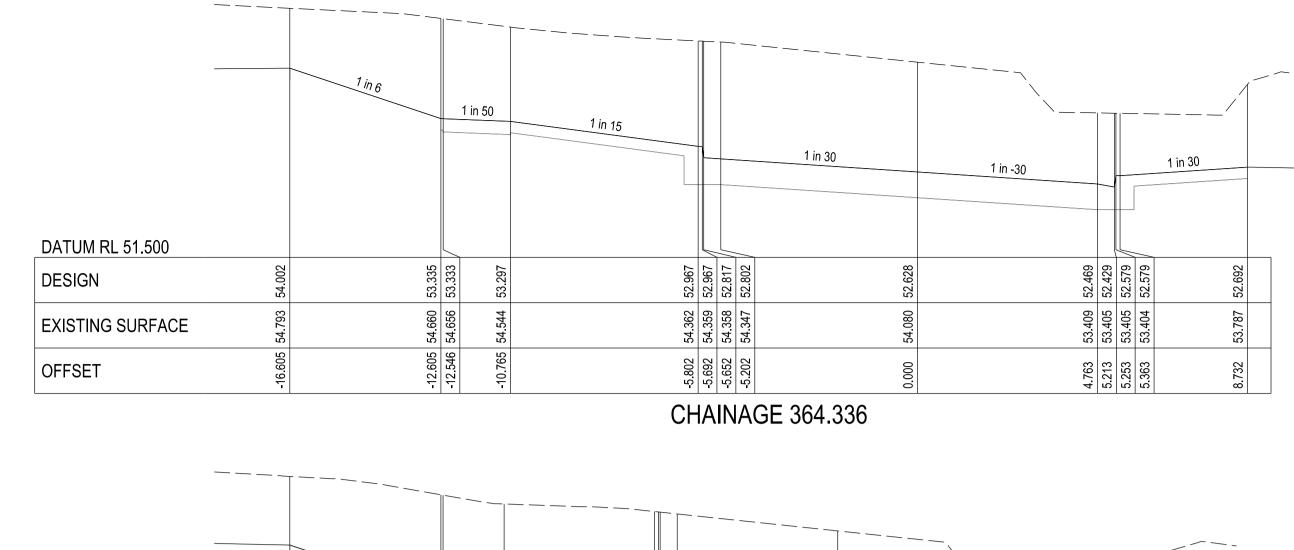


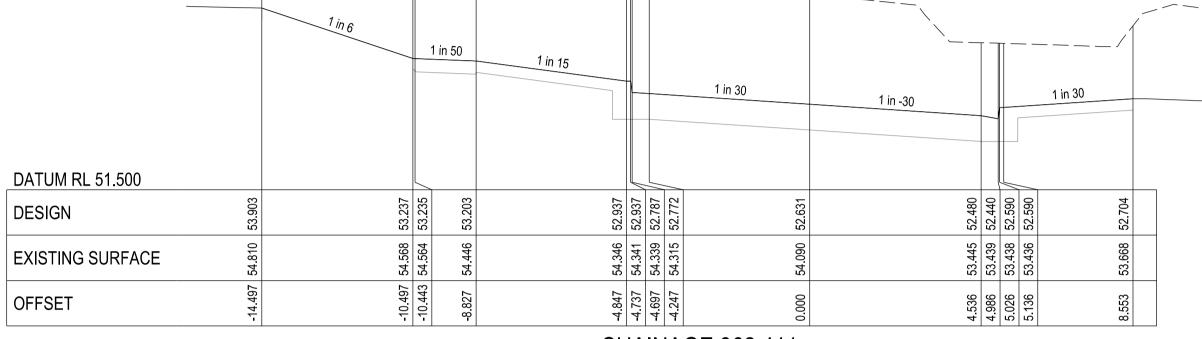

CHAINAGE 362.411

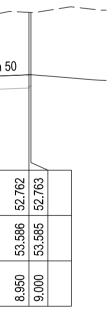


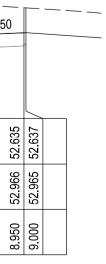


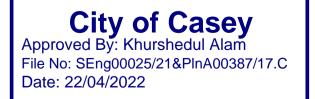

DRAWING NO: R5778


REV	DATE	[DESCRIPTION		STATUS
A	09/11/2021	FIRST COL	JNCIL SUBMISSION		PRELIMINAR
В	08/12/2021		DMMENTS 11/11/2021 ER MAIN AMENDMENT	S	PRELIMINAR
С	10/02/2022		SOVER CHANGE LOT		PRELIMINAR
FILENAME DRAWN:	E: P:\1432\^ O.FARN	432_5\E\2 - Design\6 - DG ILL DATE:	N\R07.dgn 18/10/2021	SCALE: AS SHOWN	
DESIGNED	D: M.LERN	ER DATE:	18/10/2021	DATE PRINTED: 31/03/2022	
DESIGNEE			18/10/2021 18/10/2021		
AUTHORIS SUI COUNCIL: CITY JUNC	SED: T.SMIT	H DATE: CHARCE AT ELIZA WAY, MT ELIZA VIC 3 au GE PTY LTD	18/10/2021 LTON ормент (31/03/2022	
AUTHORIS SUI WWW COUNCIL: CITY TITLE: JUNC THE J 45 CR	SED: T.SMIT	H DATE: CHARCE AT ELIZA WAY, MT ELIZA VIC 3 au GE PTY LTD	18/10/2021 Сормент (1930		

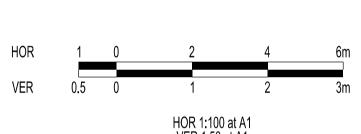

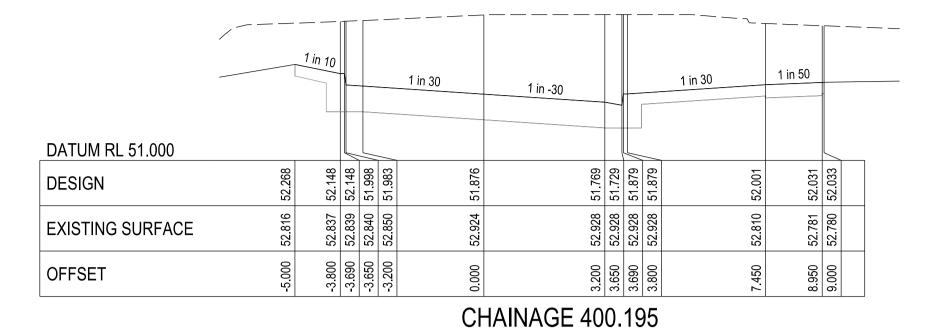


		1 in 10			1 in 30	1 in -30					1 in 30	1 in 50		
DATUM RL 51.500														
DESIGN	52.810	52.690	52.690	52.525 52.525	52.419		52.312	52.272	52.422	52.422	52.544	52.574	52.575	
EXISTING SURFACE	53.545	53.568	53.573	53.593	53.710		53.729	53.733	53.733	53.734	53.709	53.692	53.692	
OFFSET	-5.000	-3.800	-3.690	3.000	00000		3.200	3.650	3.690	3.800	7.450	8.950	000.6	

CHAINAGE 382.278

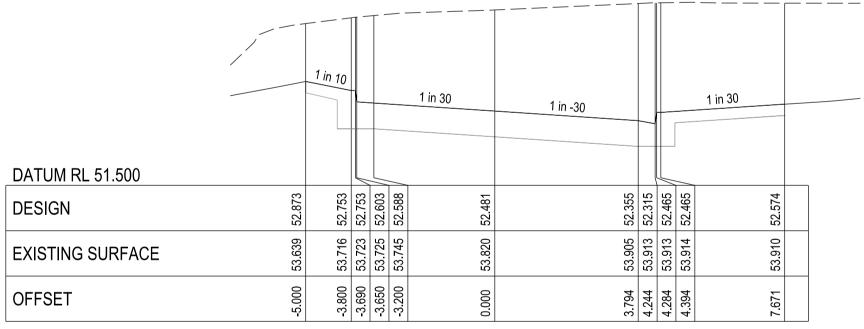

CHAINAGE 379.026

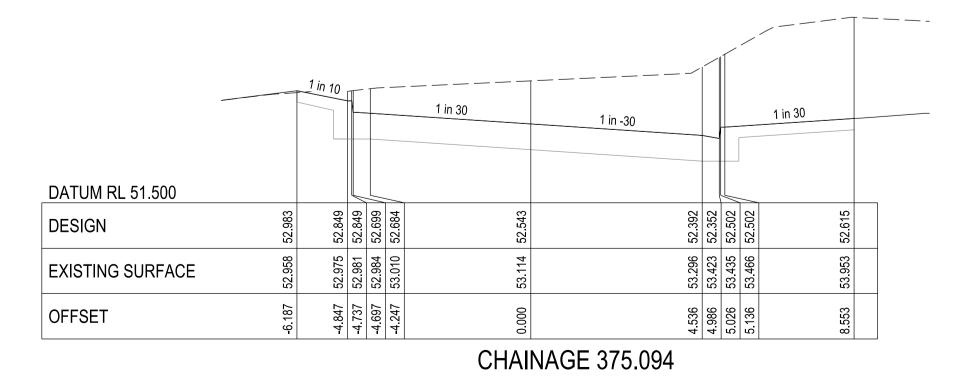

		1 in 10				1 in 30	1 in -30					1 in 30	1 in 50	1	in 6
DATUM RL 50.500			L		_						_			L	
DESIGN	51.725	51.605	51.605	51.455	51.440	51.333		51.227	51.187	51.337	51.337	51.458	51.488	51.490	51.740
EXISTING SURFACE	52.273	52.368	52.376	52.379	52.415	52.406		52.364	52.363	52.363	52.362	52.278	52.23	52.221	52.166
OFFSET	-5.000			3.650		0000		3.200		3.690		7.450	8.950		10.500
			11				CHAINAG			12	.6	95	1		


CHAINAGE 425.195 (EXISTING)

		1 in 10			1 in 30		1 in -30				1 in 30	1 in 50	-1	in 6
DATUM RL 50.000					<u>_</u>						_			
DESIGN	51.214	51.094	51.094	50.944	20.323	50.822		50.715	2/0.00	50.825 50.825	50.947	50.977	50.979	51.229
EXISTING SURFACE	51.451	51.415	51.411	51.409	10.032	51.307		51.256	51.248	51.248 51.246	51.170	51.134	51.133	51.097
OFFSET	-5.000	-3.800	3.690	3.650	-9.200	0.000		3.200	0.000	3.09U	7.450	8.950	000.6	10.500
						I	<u></u>	_		_		1		I

DRAWING NO: R5778

City of Casey Approved By: Khurshedul Alam File No: SEng00025/21&PInA00387/17.C Date: 22/04/2022

ION DETAI	_S:				
DATE		D	DESCRIPTION		STATUS
09/11/2021	F	IRST COU	INCIL SUBMISSION		PRELIMINARY
08/12/2021	CO & MIN	UNCIL CC OR WATE	DMMENTS 11/11/2021 R MAIN AMENDMENTS	6	PRELIMINARY
10/02/2022	VEHICL	E CROSS	OVER CHANGE LOT 5	20	PRELIMINARY
E: P:\1432\?	 432_5\E\2 - Desia	n\6 - DGl	N\R08.dgn		
	-		18/10/2021	SCALE: AS SHOWN	
): M.LERN	ER	DATE:	18/10/2021	DATE PRINTED: 31/03/2022	
ED: T.SMIT	Ή	DATE:	18/10/2021		
	LAND DE IT ELIZA WAY, MT EL	VEL	OPMENT C		
TION VILLA UNCTION- RAIG ROAD,	STAGE 5 JUNCTION \	/ILLAC		4	
			REV.		8 OF 10
	DATE 09/11/2021 08/12/2021 10/02/2022 2 2 3 3 4 5 5 5 5 5 7 5 7 5 7 7 10N VILLA 0.FARN	09/11/2021 F 08/12/2021 & CO & MIN 10/02/2022 VEHICL 10/02/2022 VEHICL P:\1432\1432_5\E\2 - Desig O.FARNILL P: M.LERNER ED: T.SMITH COCCHASEY TION VILLAGE PTY LTD UNCTION- STAGE 5 AIG ROAD, JUNCTION \ LILY CIRCUIT CROSS S	DATE E 09/11/2021 FIRST COU 08/12/2021 & COUNCIL CC & MINOR WATE 10/02/2022 VEHICLE CROSS 10/02/2022 VEHICLE CROSS P:\1432\1432_5\E\2 - Design\6 - DG P:\1432\1432_5\E\2 - Design\6 - DG O.FARNILL DATE: P: M.LERNER DATE: P: M.LERNER DATE: P: T.SMITH DATE: P: T.SMITH DATE:	DATE DESCRIPTION DATE DESCRIPTION 09/11/2021 FIRST COUNCIL SUBMISSION 08/12/2021 & COUNCIL COMMENTS 11/11/2021 10/02/2022 VEHICLE CROSSOVER CHANGE LOT 5 11/07/02/21 Image: Comment of the second	DATE DESCRIPTION 09/11/2021 FIRST COUNCIL SUBMISSION 08/12/2021 COUNCIL COMMENTS 11/11/2021 COUNCIL COSSOVER CHANGE LOT 520 10/02/2022 VEHICLE CROSSOVER CHANGE LOT 520 10/02/202 VEHICLE CROSSOVER CHANGE LOT 520 COLOR OF CASEY 10/02/202 COLOR OF CASEY 10/02/202 10/02/20 10/02/2

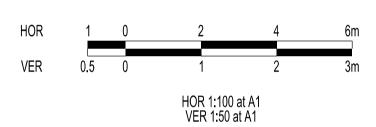

	(Ex.) (28.8)		(28	.9
		/	/	
LEGEND				
FCR BACKFILL				
PIPE GRADE (1 in) PIPE SIZE (mm)		1 in 40.2 300		1 in 49.4 300
PIPE CURVE RADIUS (m) PIPE CLASS/TYPE Vcap - CAPACITY VELOCITY (m/s) Q - PIPE FLOW (m3/s) Qcap - CAPACITY FLOW (m3/s)		Class=RCP Vcap=2.16 Q=0.151 Qcap=0.153		Class=RCP Vcap=1.95 Q=0.092 Qcap=0.138
DATUM RL	44.00			
BACKFILL TYPE				2000 200 2000 2
COVER (& NATURAL SURFACE) LEVEL	49.627 (49.509)		50.363	(51.447)
DEPTH TO INVERT	$\frac{1.755}{1.705} = -\frac{2}{0}$		1.639	
HYDRAULIC GRADE LINE			49.048 1	
INVERT LEVEL	47.872 - 4		48.724 4	
PIPE CHAINAGE	<u></u>		205.078 4	
	<u>v</u>		. 1	(70.004)

LENGTH

(32.250)


(76.994)

Pit				INTERNAL		INLET		OUTLET		PIT		
Name	TYPE	EASTING	NORTHING	WD	LEN	DIA	INV LEV	DIA	INV LEV	SETOUT RL	DEPTH	REMARKS
28.11	JP	50459.965	77324.594	600	900			300	51.737	53.001	1.264	EDCM 605
28.10	JP	50413.275	77311.389	600	900	300	50.383	300	50.333	51.968	1.635	EDCM 605
						300	50.383			51.968	1.635	Line 35 Ent
28.9	JP	50336.293	77312.765	600	900	300	48.774	300	48.724	50.363	1.639	EDCM 605
						300	48.774			50.363	1.639	Line 34 ente
34.1	DBGSEP	50338.894	77304.217	600	900			300	48.865	50.143	1.278	EDCM602
35.1	DBGSEP	50413.062	77302.892	600	900			300	50.468	51.683	1.214	EDCM602
38.1	JP	50428.246	77289.99	600	900			300	50.27	51.858	1.588	EDCM 605


NOTE:

xy setout to pit lid centre
 setout level to pit cover level

Step Irons to be provided in all pits as per EDCM609
 Pits deeper than 2.5m require either gatic or locking fibre glass type pit lids

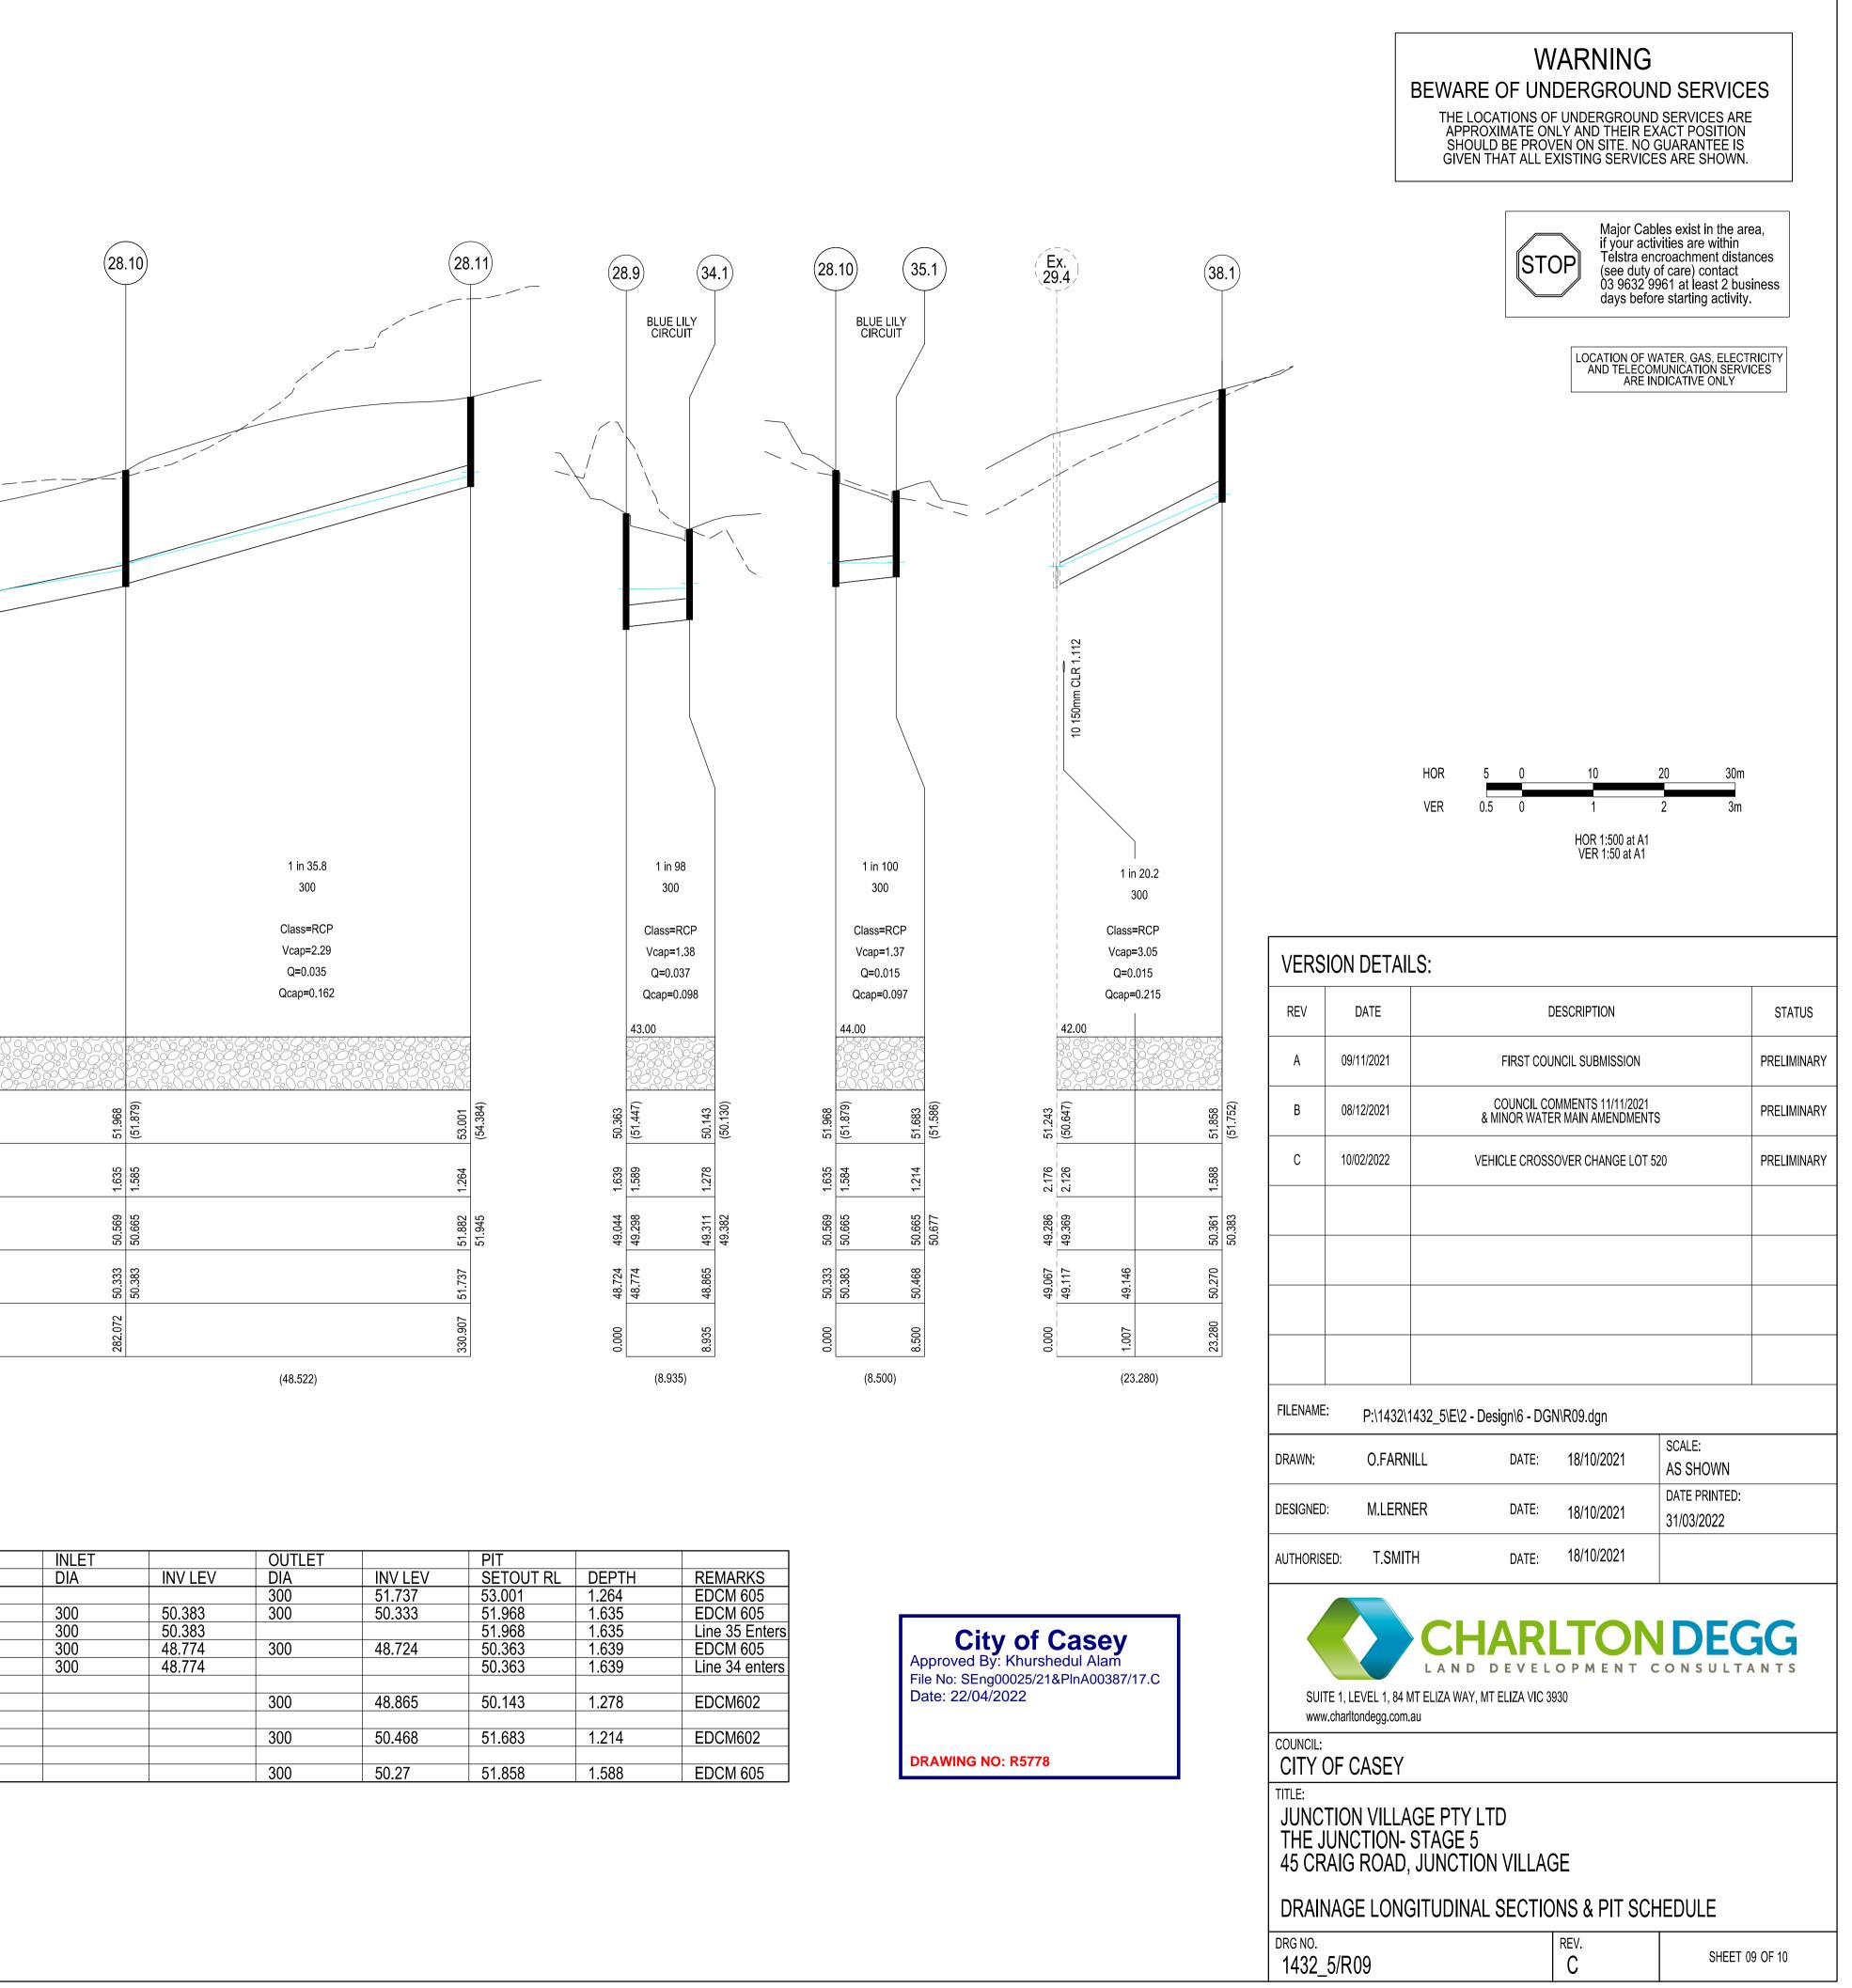

City of Casey Approved By: Khurshedul Alam	
Approved By: Khurshedul Alam	
File No: SEng00025/21&PInA00387/1	۱
Date: 22/04/2022	

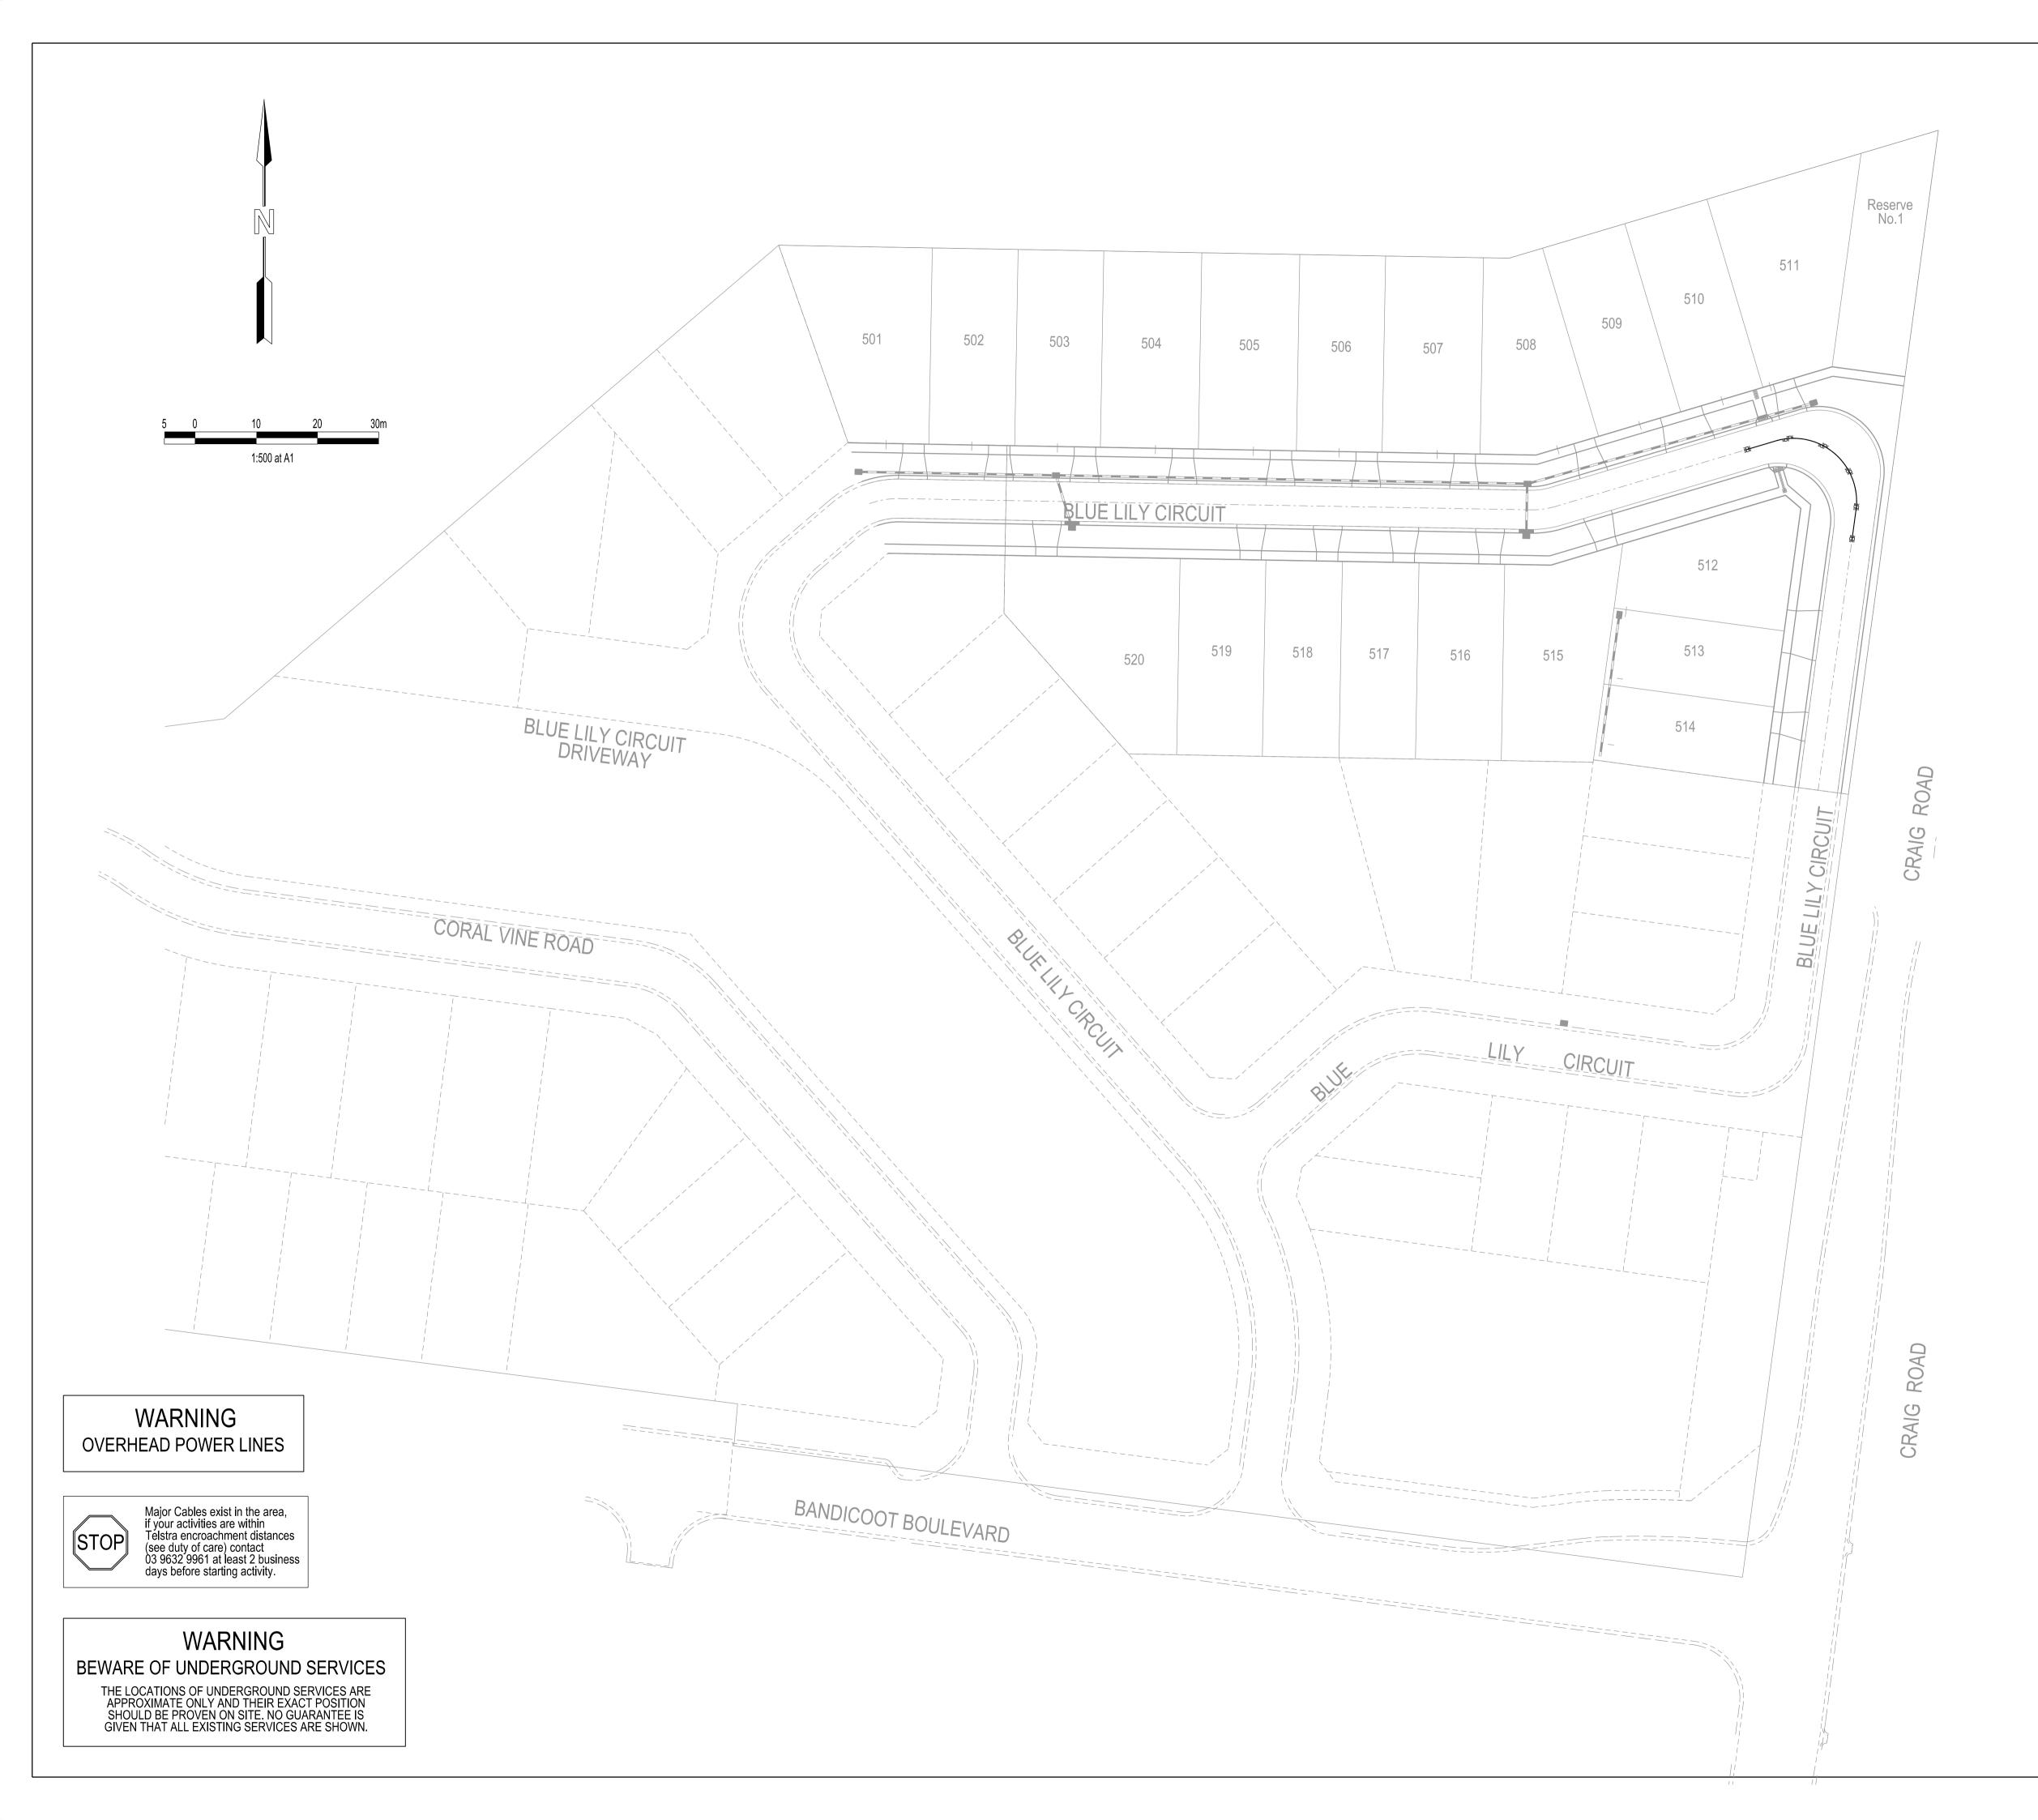

VERS	SION DETAII	_S:				
REV	DATE		D	ESCRIPTION		STATUS
A	09/11/2021		FIRST COU	NCIL SUBMISSION		PRELIMINARY
В	08/12/2021			MMENTS 11/11/2021 R MAIN AMENDMENTS	S	PRELIMINARY
С	10/02/2022	VEH	IICLE CROSS	OVER CHANGE LOT 5	20	PRELIMINARY
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DRAWN:	O.FARN	ILL	DATE:	18/10/2021	SCALE: AS SHOWN	
DESIGNED	D: M.LERN	ER	DATE:	18/10/2021	DATE PRINTED: 31/03/2022	
AUTHORIS	BED: T.SMIT	Ή	DATE:	18/10/2021		
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City of Casey Approved By: Khurshedul Alam File No: SEng00025/21&PInA00387/17.C Date: 22/04/2022